

The Department of Planning and Development Services

City Hall | 16 Colomba Road | DeBary, FL 32713

Development Review Committee (DRC) Meeting

Tuesday, June 4th, 2024 – 9:30 AM

DRC AGENDA

- CALL TO ORDER
- 2. ROLL CALL
- 3. APPROVAL OF MINUTES
 - ▶ DRC meeting on May 21st, 2024
- 4. NEW BUSINESS
 - ➤ Case # 23-01-ODP-Highbanks Townhomes; Second Review, Applicant is requesting approval of an Overall Development Plan for a residential development in the Glen Abbey PUD on East Highbanks Road, consisting of 126 townhomes, located on the properties with the Volusia County parcel IDs 80260000065 and 80270000062.
- 5. ADDITIONAL BUSINESS:
- 6. DISCUSSION:
- 7. ADJOURNMENT:

DISTRIBUTION:

Technical Review Staff:

- Steven Bapp, AICP, Growth Management Director Planning and Zoning (SBapp@DeBary.org)
- Joseph Barker, AICP, Senior Planner Planning and Zoning (JBarker@DeBary.org)
- ➤ Kayla Burney, *Planning Technician Planning and Zoning (KBurney@DeBary.org)*
- Kevin Hare, Construction Manager (KHare@DeBary.org)
- Amy Long, Public Works Director (ALong@DeBary.org)
- Chad Qualls, Public Works Superintendent (CQualls@DeBary.org)
- > Robert Scott, Orange City Fire Department (RScott@ourorangecity.com)
- Merylene Thomas, CNU-A, Senior Planner Planning and Zoning (MThomas@DeBary.org)
- Richard Villasenor, City Engineer (RVillasenor@DeBary.org)
- Steve Wood, Building Inspector (Buildingofficial@DeBary.org)
- > E-Sciences, Environmental Management Consultant (troberts@res.us)
- Fishback Dominick, Legal Consultant (DLangley@fishbacklaw.com)
- Stanley Group, Transportation Consultant (KingTanya@stanleygroup.com)
- SurvTech Solutions, Surveying Consultant (rfowler@survtechsolutions.com)
- Volusia County Utilities, Utilities (ErinReed@volusia.org)

PLEASE NOTE: Each DRC project on the agenda will take approximately 30 minutes unless otherwise noted.

APPLICANT(S): Please plan to attend the DRC meeting to discuss your project and review the comments with reviewers. Individuals with disabilities needing assistance to participate in any of these proceedings should contact the City Clerk at least three (3) working days in advance of the meeting date and time at (386) 601-0219.



City of DeBary Development Review Committee Meeting May 21, 2024 - MINUTES

CALL TO ORDER:

The meeting of the City of DeBary Development Review Committee was called to order by Richard Villasenor, City Engineer, at 9:30 am.

DRC MEMBERS PRESENT:

Richard Villasenor, City of DeBary Joseph Barker, City of DeBary Christopher Karl, Orange City Fire Department Amy Long, City of DeBary Steve Wood, City of DeBary

OTHERS PRESENT:

Kayla Burney, City of DeBary Steve Costa, Charles Wayne Properties Johnny Herbert, American Civil Engineering Co. Carmen Rosamonda, City of DeBary

APPROVAL OF MINUTES:

The meeting minutes for the May 21, 2024 Meeting Minutes were approved.

NEW BUSINESS:

Riverview Estates PUD

Project # 22-01-PUD-Riverview Estates

Steve Costa, the applicant, came forward to speak. He noted the comments have been addressed.

Joseph Barker made a motion to recommend approval of the PUD, seconded by Steve Wood. The motion was approved by a 5-0 vote.

Meadows at Glen Abbey Sketch Plan

Project # CPS24-000001

Johnny Herbert, a representative for the applicant, came forward to speak.

Christopher Karl stated the fire access must be 20 feet wide minimum. He asked if the community will be gated. Mr. Herbert stated it would be a gated community. Mr. Karl stated access to the gate system will need to be provided. Mr. Karl made note on the requirements for fire lane markings, fire flow, drawings for fire apparatus, and access to the nearby fire hydrants. Mr. Karl stated the National Fire Prevention Code would treat the proposed structures as apartment buildings and made note of the applicable requirements for the structures.

Chairman Villasenor asked if the auto-turn would be consistent with the type of crane required to access the cell tower towards the rear of the property. Mr. Herbert stated he will follow up with that information at a later time. Chairman Villasenor asked if the cell tower has a turn-around. Mr. Herbert stated there is a three-point turn.

Chairman Villasenor noted the company that maintains the cell tower will need to be able to access the gated community. Mr. Herbert stated he will coordinate with the owner of the cell tower to ensure access is available.

Chairman Villasenor stated how points of conflict between golf cart users and other users will need to be further addressed.

Chairman Villasenor asked for the landscape details to be revised or added to accommodate low permeability soils where site fill conditions exceed installations or added within native soils.

Joseph Barker made note that Section 10 of the Development Agreement permits an architectural review board. Mr. Barker asked if that will be the case. Mr. Herbert stated he does not have that information and he will provide it at a later time.

Mr. Barker asked if there would be any solid waste containers on site. Mr. Herbert stated there would not be and that residents would have their own trash cans.

ADJOURNMENT:

The meeting was adjourned at 9:44 AM.

DRC 6-4-2024

Subject Case # 23-01-ODP-Highbanks Townhomes

Applicant: Tailwinds Development, LLC

Application Summary:

The applicant is requesting approval of an Overall Development Plan for 126 Townhome units off of East Highbanks Road located on the parcels with the Volusia County IDs 80260000065 and 80270000062.

Planning & Zoning Joseph Barker, Senior Planner, AICP Candidate

Regarding Case # 23-01-ODP-Highbanks Townhomes, staff offers the following comments.

Comprehensive Plan Review:

In reviewing the application (proposed project), staff has reviewed it against the policies contained within the City's Comprehensive Plan (Plan) to determine whether or not the proposed project is consistent with the Plan, as required by Florida Statute 163.3194, and Section 1-2(b)(1) of the City's Land Development Code.

Future Land Use

The goal of the City's Future Land Use element of the Plan is to facilitate the development and use of land, including permanent open space, in an organized arrangement which supports the appropriate development of the overall community, including an efficient multi-modal transportation system that enhances the well-being of the City's residents and businesses.

Objective 5.1 states the City will carry out a program of activities to provide for its future growth by designating adequate land for the development of necessary land uses (including open space and public facility land uses), consistent both with the availability of needed public facilities and with the efficient use of such facilities.

Policy 5.106 states the City will ensure that adequate land is available for public facilities and utilities. During the development review process, plans for development of utilities and public facilities will be examined and any land necessary which may be provided in connection with the subject development will be reserved or acquired, as appropriate. Consideration of the City's 5-year Capital Improvement Program (CIP) should be considered. There are multiple projects within the CIP that could be impacted by this development, including the East Highbanks right-turn-lane.

Objective 5.5 states the City has established a set of land development regulations to implement and support the provisions of the Plan. Policy 5.505 mandates the City to consider the following when making a decision regarding the approval of a development:

- a. The impact of the proposed development on the natural environment and the capability to adequately mitigate any adverse impacts;
- b. The impact of the proposed development on existing and future development in the vicinity, including impacts on public facility capacity, adequate water supplies and associated public facilities, environmental impacts, the resulting appearance of the overall community, and the subsequent ability to properly develop or redevelop other nearby land;
- c. The reasonableness of the development vis-a-vis good design, orderly pattern of development, compatibility with the development of nearby areas, safety and convenience of occupants and the general public, and the presence or absence of unusual features which are favorable to successful or unsuccessful development;
- d. The availability of other suitable land (properly located and with the necessary characteristics) to serve the needs represented by the proposed development; and
- e. Whether there are mitigating or unusual circumstances (such as the potential for a taking to exist if no development is approved) which might be addressed through the approval of the development, with or without amendments or conditions.

Regarding impact on the natural environment, please refer to comments from Environmental Management. Please note that architectural elevations will need to be submitted to ensure compatibility in appearance with the overall community (Glen Abbey).

These may be submitted during the Preliminary Plat & Construction Plan application. Consideration will need to be given in regard to pedestrian connectivity and accessibility.

Transportation

The goal of the City's Transportation element is to facilitate the development of a safe, costeffective, coordinated, connected, energy efficient, multimodal transportation system for the movement of people and goods to benefit the social, economic and physical development of the City and to reduce greenhouse gas emissions and vehicle miles of travel.

Objective 6.1 mandates the City to carry out a program of activities to facilitate the provision of a cost-effective, safe, convenient, and energy efficient multimodal transportation system. **Please see comments from Transportation.**

Objective 6.3 mandates the City to carry out a program of activities to provide for the protection of future rights-of-way for roads and mass transit facilities (including exclusive mass transit corridors).

Policy 6.302 mandates the City to consider the needs for future transportation rights-ofway in reviewing plans for major land developments. **Please see comments from Transportation.**

Objective 6.5 mandates the City to carry out a program of activities to address the provision of efficient public transportation (including paratransit) services based on existing and proposed major trip generators, safe and convenient public transit terminals, and accommodation of passengers with special needs.

Policy 6.502 mandates the City to support development of appropriate facilities through the land development review process, as well as through design of City projects. Such facilities might include bus shelters, bus pull-outs, fringe parking facilities, and optimum street layouts. **Proper consideration must be given to the development of appropriate facilities.**

Objective 6.7 requires the City to support the expansion of the SunRail commuter rail system, bus transportation, and bicycle and pedestrian facilities and reduce emphasis on transportation system improvements that favor the use of single-occupancy vehicles as the primary means of transportation.





Policy 6.703 requires the City to develop a program for bicycle and pedestrian connections along US Hwy 17/92 and other streets, pathways and trails linking DeBary Commuter Rail Station with the transit oriented development, South East Mixed Use Area, and the Village Center Area. Consideration should be given to creating bicycle and pedestrian connections to U.S. Highway 17/92.

Public Facilities Infrastructure

The goal of the City's Public Facilities Infrastructure element is to facilitate the development of adequate public infrastructure to serve the appropriate growth and development of the City, and with appropriate consideration to managing important natural resources.

Objective 7A mandates the City to carry out a program of activities to correct existing deficiencies in potable water treatment and distribution facilities, to provide adequate potable water facilities and to meet the needs of future growth. **Please see comments from Volusia County Utilities.**

Objective 7B mandates the City to carry out a program of activities to correct existing deficiencies in sanitary sewer collection and treatment facilities and to provide adequate sanitary sewer facilities to support high density mixed use developments within the Southeast Mixed Use Area/Transit Oriented Development District and to meet the needs of future growth. **Please see comments from Volusia County Utilities.**

Objective 7C mandates the City to carry out a program of activities to correct existing deficiencies in the stormwater management system and to provide adequate facilities to support high density mixed use developments within the Southeast Mixed Use Area/Transit Oriented Development Overlay District and to meet the needs of future growth. **Please see comments from Engineering.**

Capital Improvements

The goal of the City's Capital Improvements element is to facilitate the efficient provision of public facilities through coordination between needs and resources and through coordination between capital projects plans and the community's objectives as set forth in this Plan.

Objective 10.1 mandates the City to carry out a continuing program of activities to plan and construct capital facilities so as to reduce existing deficiencies, so as to provide for replacement of



obsolete or worn-out facilities, and so as to provide for the appropriate growth and development of the community.

Policy 10.104 provides for regulatory level of service (LOS) standards. **These standards** should be taken into consideration. Please see Policy 6.704 for potential remedies if the LOS is insufficient.

Objective 10.3 requires the City to ensure that the capacity of schools is sufficient to support residential subdivisions and site plans at the adopted level of service standard. This level of service standard shall be consistent with the level of service standard adopted in the interlocal agreement entered into by the School Board and the local governments within Volusia County.

Policy 10.302 provides for LOS standards for elementary schools. The adopted standard is 115% of permanent Florida Inventory of School Houses (FISH) capacity. According to the 2023-2023 School Year LOS Chart (revised 3/1/2023), the utilization rate of DeBary Elementary with reserve was 116.5% for the current year. For the 2023-2024 School Year, it is projected to be 124.1%. For more information regarding public school facility capacity, please see Chapter 12 of the Plan.

For all other elements of the Plan not discussed in this report, the project has been determined to be consistent with those elements.

Land Development Code Review:

The proposed project has been reviewed against the provisions of the City's Land Development Code (LDC).

Zoning

LDC Chapter 3, Article III, Division 3 provides for zoning classifications and development standards therein. This property is zoned Planned Unit Development (PUD), Swallows Golf and Country Club. Thus, the project is subject to the zoning regulations prescribed in Ordinance # 07-2024, specifically the Swallows Golf and Country Club Development Agreement (DA). This PUD is commonly referred to as "Glen Abbey" and will be referenced as such herein.

Section 6 of the DA prescribes development standards for townhome dwellings. Please correct the following:



- Southernmost lots on Sheet C1.2 are 1,880 square feet. Minimum lot size is 1,900. This appears to be due to the building being 94 feet deep while the others are 95 feet deep.
- The structure adjacent to the amenity center appears to not meet the 10-foot rear yard setback requirement.
- The four structures on the west end of Sheet C1.3 appear to not meet the 10-foot rear yard setback requirement.
- Please provide clarification on minimum floor area data depicted on Sheet C5.0, which states the minimum floor area is 1,200 square feet for the primary unit. The DA states the minimum floor area is 575 square feet.
- Please provide clarification on the minimum building setbacks depicted on Sheet C5.0. They seem to conflict with the DA.
- Sheet C5.0 states the maximum pervious lot coverage shall be 80%. LDC Chapter 4, Article II, Division 4, Section 4-81(f) states the area covered by structures and impervious surface shall not exceed 75% for any lot.

Supplementary Regulations

In addition to the development standards of the DA, LDC Chapter 3, Article III, Division 4 contains supplementary regulations that must be followed.

Please note at the time of preliminary plat submittal that details on lighting for the parking areas must be provided to ensure no artificial lighting will be directed upon adjacent properties.

Overall Development Plan Requirements

LDC Chapter 4, Article II, Division 2, Section 4-44 provides for requirements for overall development plan applications. Please provide the following site details:

- Please provide a scale for the vicinity map.
- Total linear feet in streets.
- Easement locations (e.g., utility easement)





<u>Design and Construction Standards of Improvements</u>

LDC Chapter 4, Article II, Division 4 provides for requirements of design for new subdivisions and standards for the construction of improvements.

Section 4-85 provides for requirements for utility easements, water and wastewater easements, and drainage and maintenance easements. **Please delineate these easements.**

Section 4-90 provides for requirements for sidewalks. Section 4-90(b)(1) requires paved sidewalks a minimum of 5 feet in width to be installed on both sides of all local streets within a new development. **Please provide sidewalks on both sides of all local streets.**

Landscaping and Buffer Standards

LDC Chapter 5, Article I provides for landscaping and buffer standards.

Section 5-4 provides for the provision of buffer yards and screening. On Sheet L1.03, there is an area in the northern landscape buffer lacking landscaping. On Sheet L1.02, there is an area in the southern landscape buffer lacking landscaping. Please provide clarification.

Section 5-5 provides for site fixtures. Will there be a project identification sign? If so, please ensure it will not be oriented toward or visible from an adjacent single-family residential district.

Please note at the time of preliminary plat submittal that details on lighting must be provided to ensure the lights are hooded and shielded so that the light source is not directly visible from an adjacent single-family residential district.

Section 5-7 provides for landscaping requirements for building perimeters. Please provide a continuous landscape area with a minimum depth of 5 feet adjacent to all building perimeters where possible.

Section 5-8 provides for landscaping requirements for vehicular use areas. Please ensure the ends of planters next to parking stalls are set back 2 feet from the roadway.

Section 5-10 provides for planting design and distribution requirements. Trees shall be placed in the building perimeter landscape area at the corners of buildings along the building façade so that there is at least one tree per building side and no more than 50 lineal feet of wall between trees.

Please provide a note on Sheet L1.00 stating all landscape areas shall be designed with plant spacing to achieve coverage of 80% of the landscape areas with living organic plant materials within 2 years.

Accent plantings shall be placed at building corners.

Section 5-12 provides for irrigation requirements. On Sheet L2.01, the landscaping fronting East Highbanks Road does not appear to have irrigation.

Please add a note stating that sprinkler heads shall be spaced so that spray patterns overlap by at least 75%.

Section 5-13 provides for materials specifications. Will the canopy trees be capable of reaching a minimum height of 25 feet and crown spread of 15 feet at maturity?

Public Works Department Amy Long, Deputy Public Works Director

No comments have been received.

Fire Services Robert Scott, Fire Marshal

- 1. Water line are shown on plans, but doesn't show any Fire Hydrants placement. Provide details on Fire Hydrants and Fire Flow requirement per the Florida Fire Prevention Code 7th ED of NFPA 1 Chapter 18 Section 18.1.3.2 and 18.4 for review.
- 2. Page C1.0 shows dead-end roads. Provide details on distance length of roadways. The Florida Fire Prevention Code 7th ED of NFPA 1 Chapter 18 Section 18.2.3.5.4.
- 3. Provide CAD Drawings for turning radius. The Florida Fire Prevention Code 7th ED of NFPA 1 Chapter 18 Section 18.2.3.5.3.

4. Plans don't show any Fire Lanes. Provide details to meet the Florida Fire Prevention Code 7th ED of NFPA 1 Chapter 18 Section 18.2.3.6.3.

Engineering Richard Villaseñor, P.E., City Engineer

No comments have been received.

Building Department Steve Wood, Building Official

No comments have been received.

Volusia County Utilities Erin Reed, PhD, P.E., Water & Utilities Senior Engineer

VCU has reviewed the submittal and has the following comments:

- 1. Please show the connection to existing sewer.
- 2. Reference appropriate VCU standard detail for water main connection, meter, and backflow.
- 3. Please call-out the potable tap and specify a stainless steel tapping sleeve at the potable tap location.
- 4. VCU does not allow separate meters for irrigation unless it is connected to reclaimed water. Please remove the tee prior to the master meter.
- 5. Please visit Volusia County Water Resources & Utilities' website to obtain the most recent (2024) Standard Details, Specifications, and a list of approved materials including piping, fittings, valves, meters, etc. for applicable water, sewer, and reclaimed infrastructure: https://www.volusia.org/services/public-works/water-resources-andutilities/utility-engineering.stml
- 6. Payment of the county's utility development fees is required before utility service will be provided. The county's utility development fee schedule and commercial water/sewer



service application are available online at: https://www.volusia.org/services/public-works/water-resources-and-utilities/utility-engineering.stml

Environmental Management Tom Roberts, Regional Science Manager, RES

All wetland, tree and protected species comments have been satisfactorily addressed by the applicant in their provided documents. RES has no additional questions or comments at this time.

Transportation

Tanya King, PE, Senior Transportation Engineer, TEDS

The October 2023 TIA Methodology Letter from Kimley-Horn addressed my previous comments (see attached). We offer no additional comments.

END OF COMMENTS

A written response to each of the above comments will be required when revisions are re-submitted to the City. Please be advised that additional comments may be forthcoming after a review of the revised plan set has been completed.

If you should have any questions, please feel free to contact me at 386-601-0203.


Steven Bapp, AICP Sbapp@debary.org Director of Growth Management City of DeBary

HIGHBANKS TOWNHOMES

DEBARY, FLORIDA April 26, 2024

PARCEL ID:

80-27-00-00-00-62, 80-26-00-00-00-65

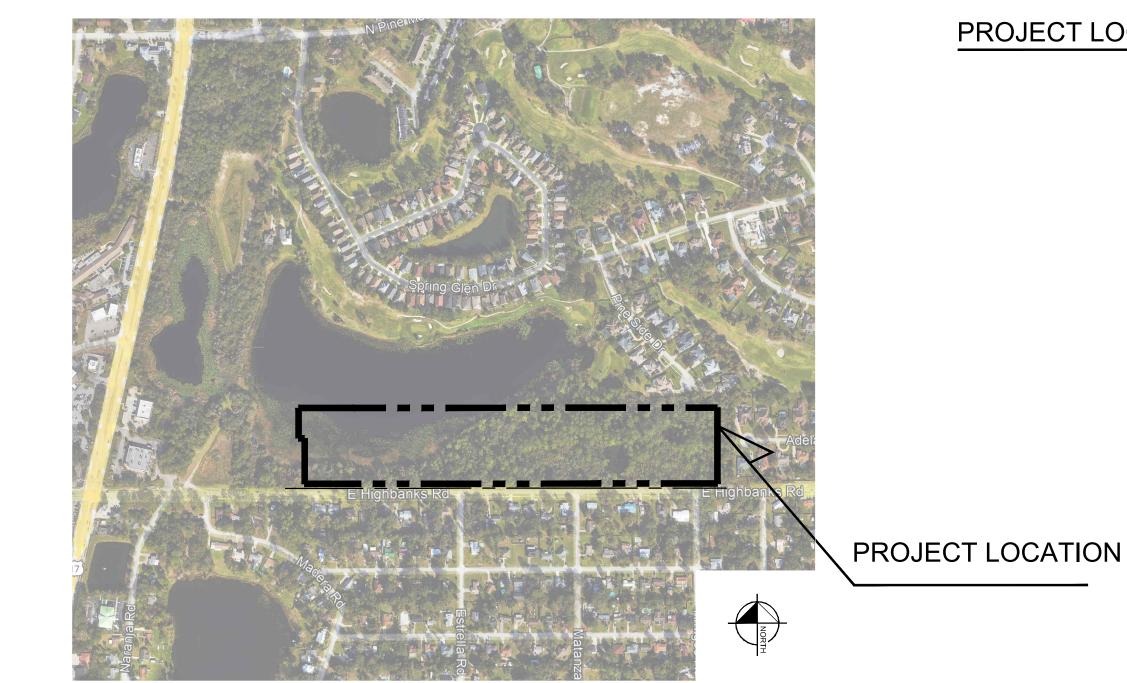

AERIAL MAP SECTION 27, TOWNSHIP 18, RANGE 30

PROJECT TEAM

DEVELOPER: OWNER:

TAILWINDS DEVELOPMENT, LLC 100 COLONIAL CENTER PKWY, LAKE MARY, FL 32746 CONTACT: STEPHEN T. INFANTINO PHONE: (407) 721-6051 EMAIL: SINFANTINO@TWDRE.COM

1111 S LAKEMONT AVE WINTER PARK, FLORIDA 32792

STEDRONSKY GEORGE R TR


CIVIL ENGINEER: KIMLEY-HORN AND ASSOCIATES, INC.

189 S. ORANGE AVENUE, SUITE 1000 ORLANDO, FL 32801 CONTACT: JOSH ENOT, P.E. PHONE: (321) 754-0413 EMAIL: JOSHUA.ENOT@KIMLEY-HORN.COM SURVEYOR CHARLES ROB DEFOOR P.O. BOX 1472 GENEVA, FLORIDA 32732 PHONE:(407) 880-9811

PREPARED BY

CALL 48 HOURS **BEFORE YOU DIG** IT'S THE LAW! Know what's below. **DIAL 811** Call before you dig.



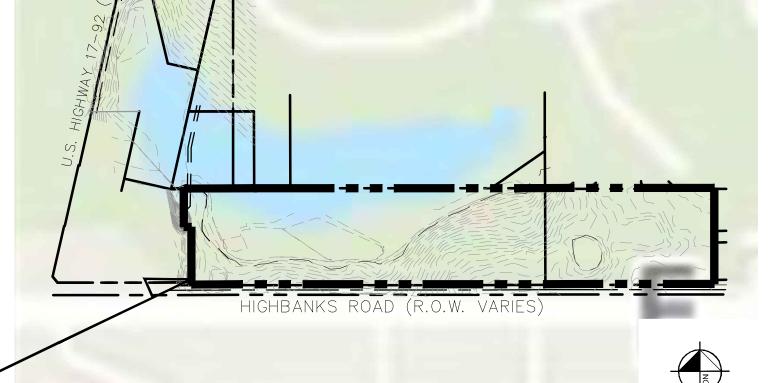

TOPOGRAPHIC MAP

LEGAL DESCRIPTION

PROJECT LOCATION

WAY PER OFFICIAL RECORDS BOOK 2136, PAGE 1262, PUBLIC RECORDS OF VOLUSIA COUNTY, FLORIDA; LYING EAST OF THE OLD EAST RIGHT-OF-WAY LINE OF U.S. HIGHWAY 17-92, A 100 FOOT WIDE PUBLIC RIGHT-OF-WAY, LYING WEST OF A LINE THAT IS PARALLEL AND 500 FEET EASTERLY OF THE OLD RIGHT-OF-WAY LINE OF U.S. HIGHWAY 17-92 AND NORTH OF DEBARY CORNERS, ACCORDING TO THE PLAT THEREOF, AS RECORDED IN PLAT BOOK 55, PAGES 21-23, PUBLIC RECORDS OF VOLUSIA COUNTY, FLORIDA

LESS AND EXCEPT:

CERTAIN PARCELS OF LAND TAKEN AS ADDITIONAL RIGHT-OF-WAY AND DRAINAGE RETENTIION AREA FOR STATE ROAD 15/600 (U.S. 17-92) ACCORDING TO THE FLORIDA DEPARTMENT OF TRANSPORTATION RIGHT-OF-WAY MAP FOR STATE ROAD 15/600.SECTION NUMBER 79040-2503, SHEETS 3, 4, 5 AND 12 OF 16, MORE PARTICULARLY DESCRIBED IN FINAL JUDGEMENT RECORDED IN O.R. BOOK 4401, PAGE 2212, PUBLIC RECORDS OF VOLUSIA COUNTY, FLORIDA.

PARCEL 2:

A PARCEL OF LAND BEING A PORTION OF THE SOUTHEAST 1/4 OF SECTION 27, TOWNSHIP 18 SOUTH, RANGE 30 EAST, VOLUSIA COUNTY, FLORIDA, MORE PARTICULARLY DESCRIBED AS FOLLOWS:

COMMENCING AT A POINT ON THE EAST SECTION LINE 25 FEET NORTHERLY OF THE SOUTHEAST CORNER OF SAID SECTION 27. RUN THENCE SOUTH 89 DEG. 41' 25" WEST, ALONG THE NORTH RIGHT-OF-WAY LINE OF HIGHBANKS ROAD A DISTANCE OF 2576.00 FEET TO THE INTERSECTION OF THE NORTH RIGHT-OF-WAY OF HIGHLANDS ROAD AND THE EAST RIGHT-OF-WAY OF U.S. HIGHWAY 17-92, AS IT EXISTED ON MAY 28, 1974, THENCE NORTH 12 DEG. 30' 50" EAST, ALONG THE SAID EAST RIGHT-OF-WAY LINE OF U.S. HIGHWAY 17-92 A DISTANCE OF 928.14 FEET, THENCE NORTH 89 DEG. 41' 25" EAST. A DISTANCE OF 512.79 FEET TO THE POINT OF BEGINNING; THENCE CONTINUE NORTH 89 DEG. 41' 25" EAST, A DISTANCE OF 340.96 FEET TO A POINT ON A LINE THAT IS PARALLEL WITH THE EAST LINE OF SAID SECTION 27; THENCE RUN SOUTH 00 DEG. 29' 32" EAST, FOR A DISTANCE OF 400.00 FEET TO A POINT ON THE NORTH LINE OF THE SOUTH 530 FEET OF THE SOUTHEAST 1/4 OF SAID SECTION 27: THENCE RUN SOUTH 89 DEG. 41' 25" WEST, ALONG SAID NORTH LINE OF THE SOUTH 530 FEET OF THE SOUTHEAST 1/4 FOR A DISTANCE OF 433.29 FEET TO A LINE 500 FEET EASTERLY OF AND PARALLEL WITH THE SAID EAST RIGHT-OF-WAY LINE OF U.S. HIGHWAY 17-92; THENCE RUN NORTH 12 DEG. 30' 50" EAST, ALONG SAID PARALLEL LINE FOR A DISTANCE OF 410.23 FEET TO THE POINT OF BEGINNING.

THE SOUTH 525 FEET OF THE WEST 864.79 FEET OF THE SOUTHWEST 1/4 OF SECTION 26, TOWNSHIP 18 SOUTH, RANGE 30 EAST, LESS ROAD RIGHT-OF-WAY FOR HIGHBANKS ROAD.

THAT PORTION OF THE SOUTH 530.00' OF THE SOUTHEAST 1/4 OF SECTION 27, TOWNSHIP 18 SOUTH, RANGE 30 EAST, LYING EAST OF DEBARY CORNER, ACCORDING TO THE PLAT THEREOF, AS RECORDED IN PLAT BOOK 55, PAGE 21-24, OF THE PUBLIC RECORDS OF VOLUSIA COUNTY, FLORIDA SOUTH OF THE DEBARY GOLF COURSE AND SPRING GLEN, UNIT 2, ACCORDING TO THE PLAT THEREOF, AS RECORDED IN PLAT BOOK 47, PAGE 103-107, OF THE PUBLIC RECORDS OF VOLUSIA COUNTY, FLORIDA; LESS ROAD RIGHT-OF-WAY FOR

PART OF THE ABOVE REFERENCED PROPERTY IS LOCATED IN ZONE 'A', AREA OF 100 YEAR FLOODING, WITH NO BASE FLOOD ELEVATION PROVIDED WITH THE BALANCE OF SAID PROPERTY BEING LOCATED IN ZONE 'X', AREA OF MINIMAL FLOODING, AS PER F.I.R.M. COMMUNITY PANEL NO. 12127C0620 K, VOLUSIA COUNTY, FLORIDA. MAP DATED SEPTEMBER 29, 2017.

UTILITY PROVIDERS

VICINITY MAP

WATER, SEWER, & RECLAIM WATER: VOLUSIA COUNTY WATER & UTILITY 3151 E. NEW YORK DELAND, FL, 32720 CONTACT: EARL FARMER

PROJECT LOCATION

eBary Golf &

Country Club

PROJECT LOCATION

POWER: **DUKE ENERGY** DELAND, FL 32720

PHONE: (800) 700-8744

400 N SPRING GARDEN AVE

lighbanks Rd

FLORIDA GAS TRANSMISSION COMPANY

2405 LUCIEN WAY, SUITE 200 MAITLAND, FL 32751 CONTACT: JOSEPH E. SANCHEZ PHONE: (407) 838-7171

Saxon Blvd

SHEET INDEX

L0.50-L0.55

COVER C1.0-C1.3 SITE PLAN

PHONE: (386) 804-7788

C2.0-C2.3 PAVING, GRADING, AND DRAINAGE

TREE MITIGATION PLAN

[17]


Glen Abbey


Golf Club


C3.0-C3.3 **UTILITY PLAN**


TYPICAL ROAD SECTIONS C4.0 LOT DIMENSIONS

SUNSHINE STATE ONE CALL OF FLORIDA, INC.

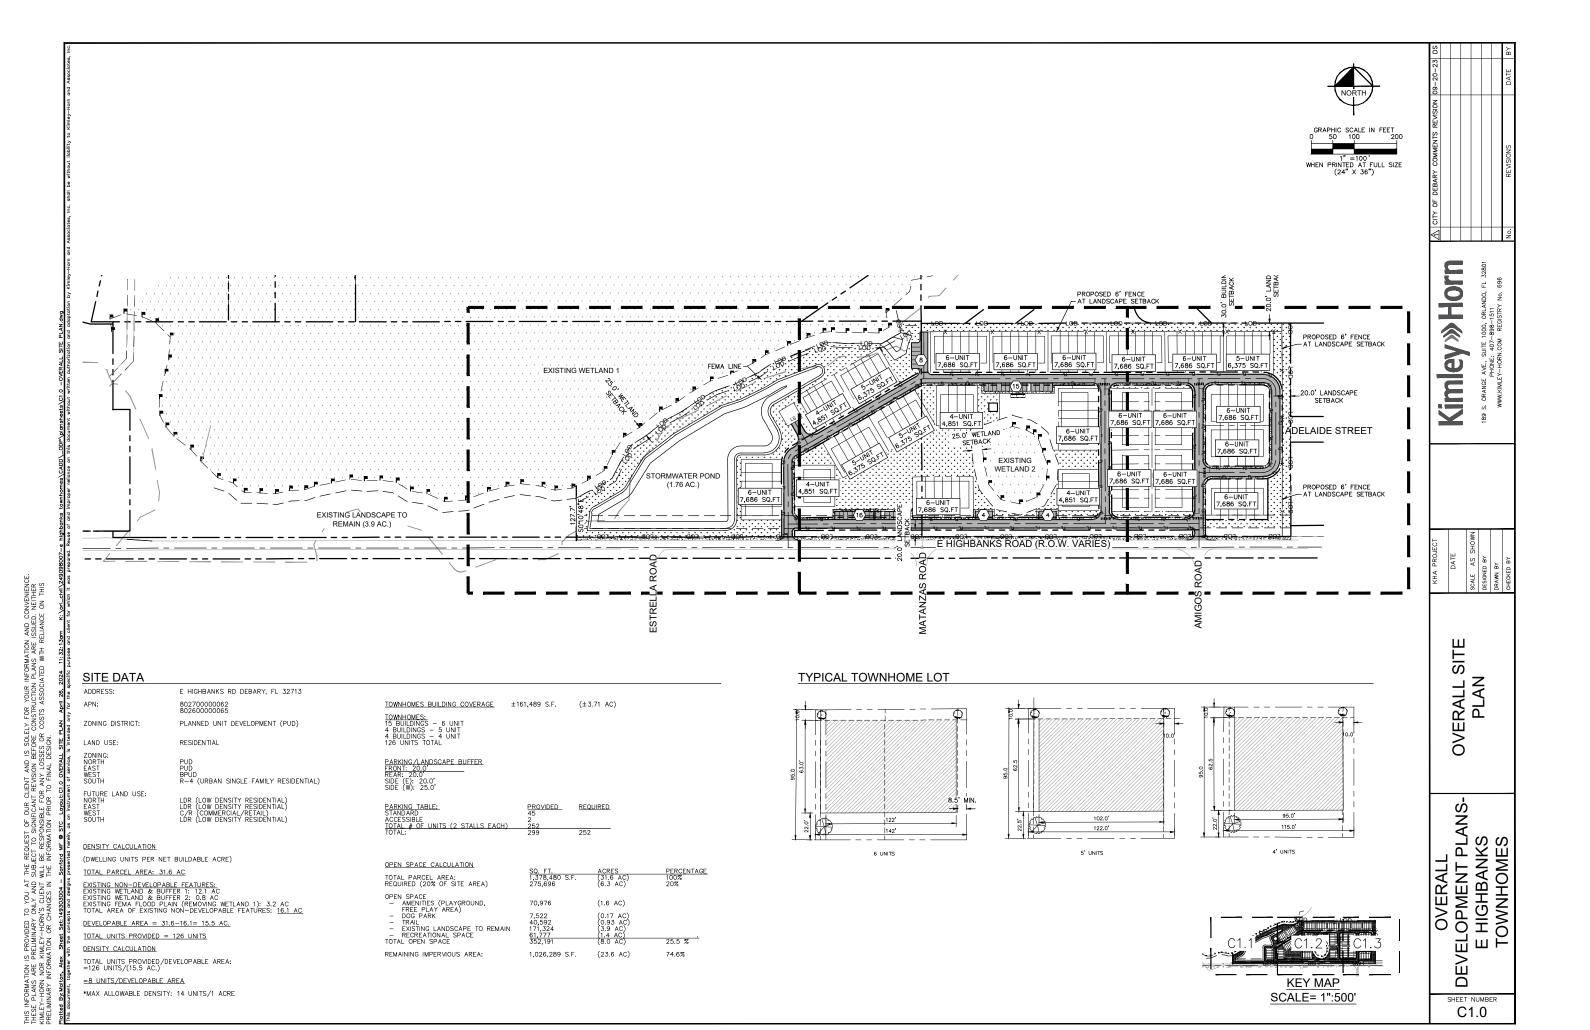


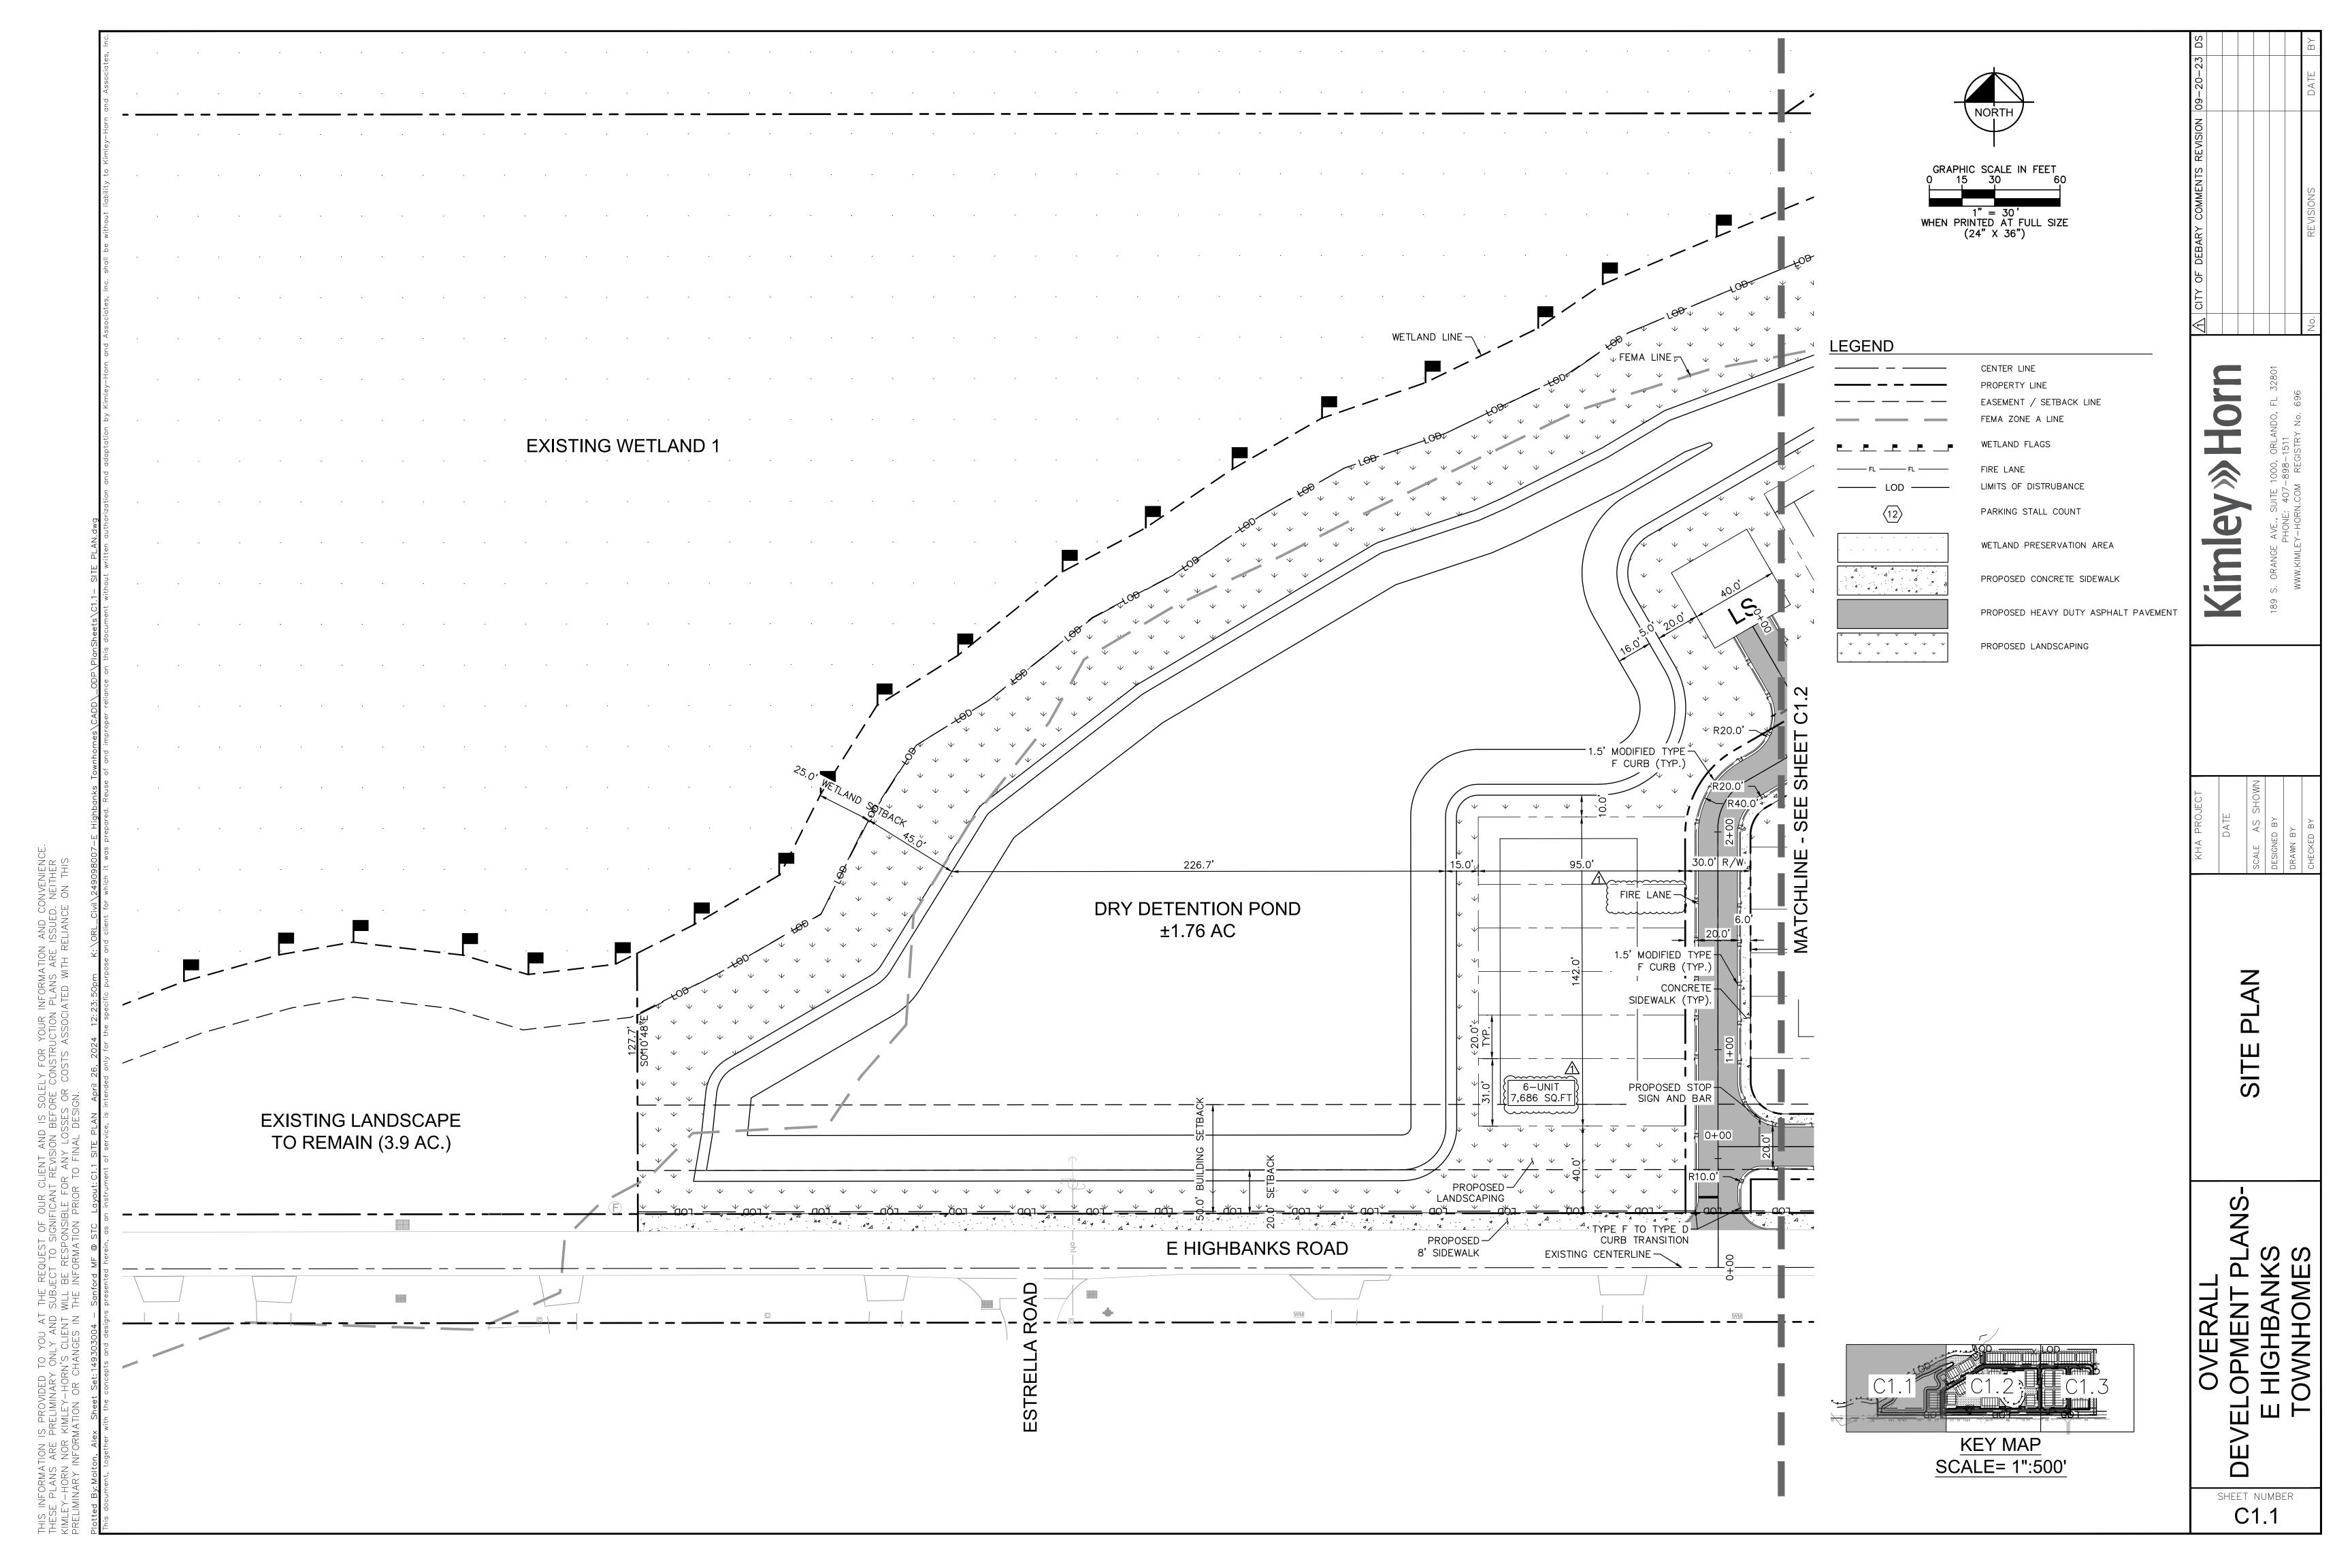

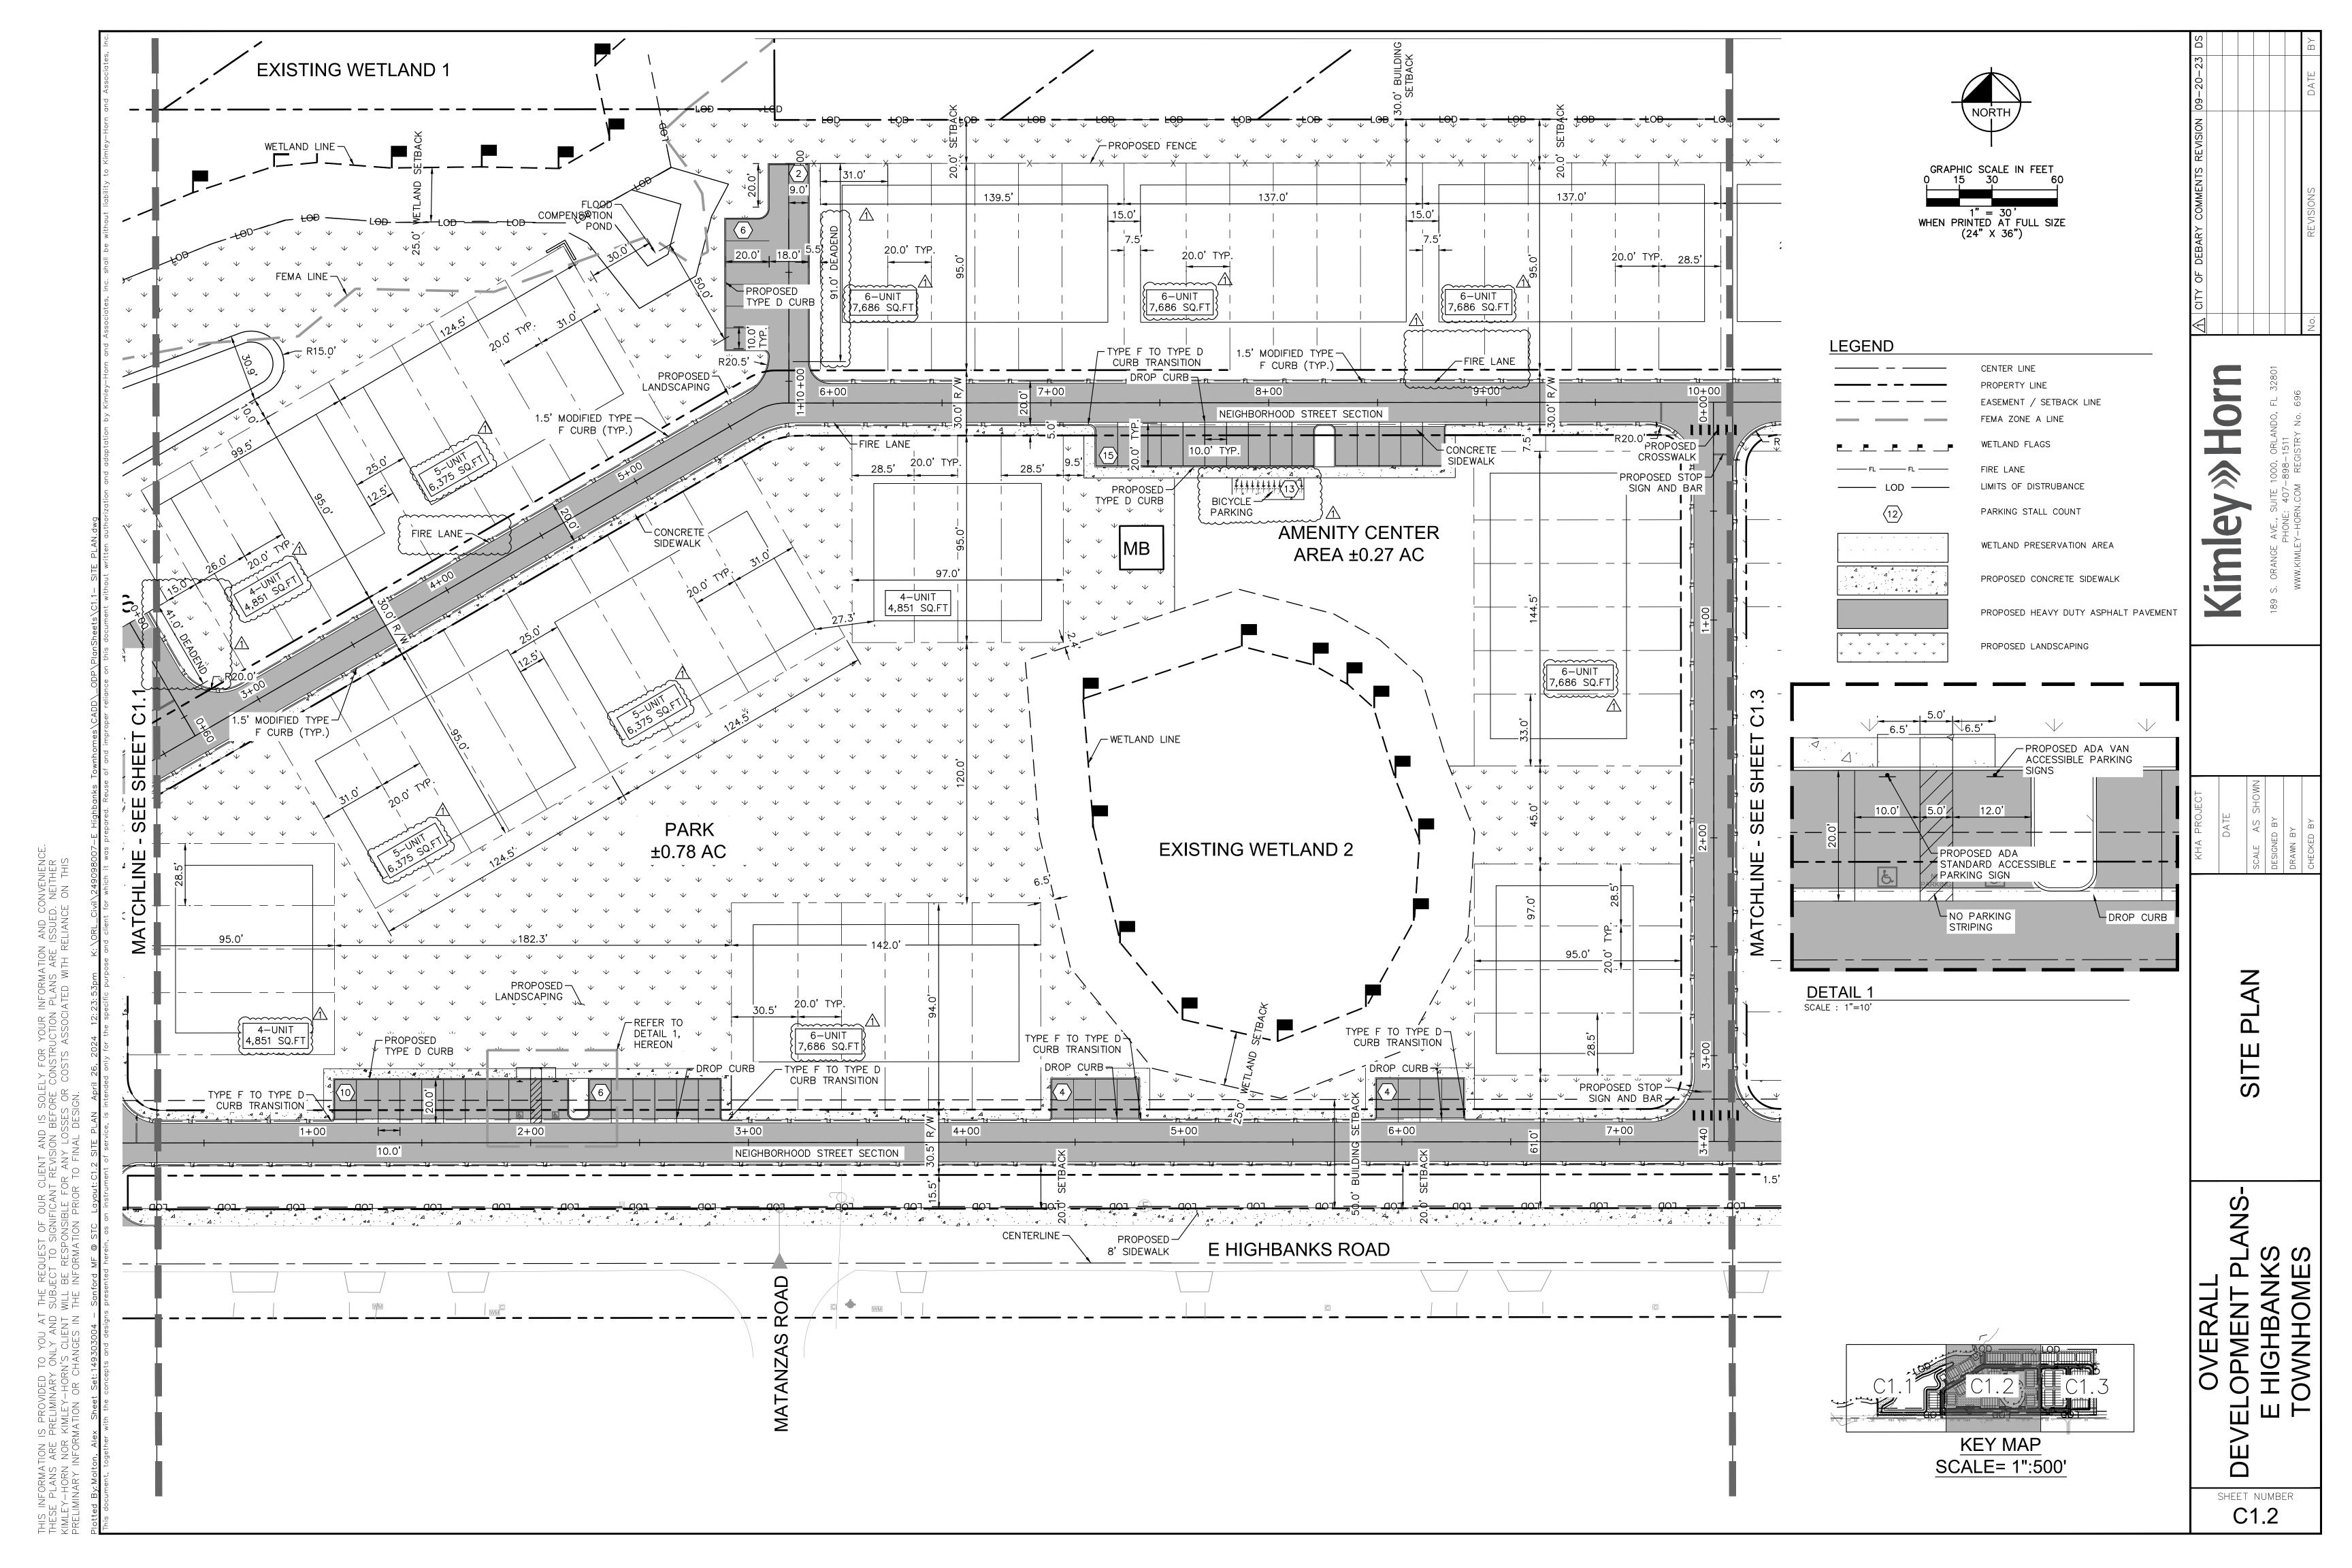

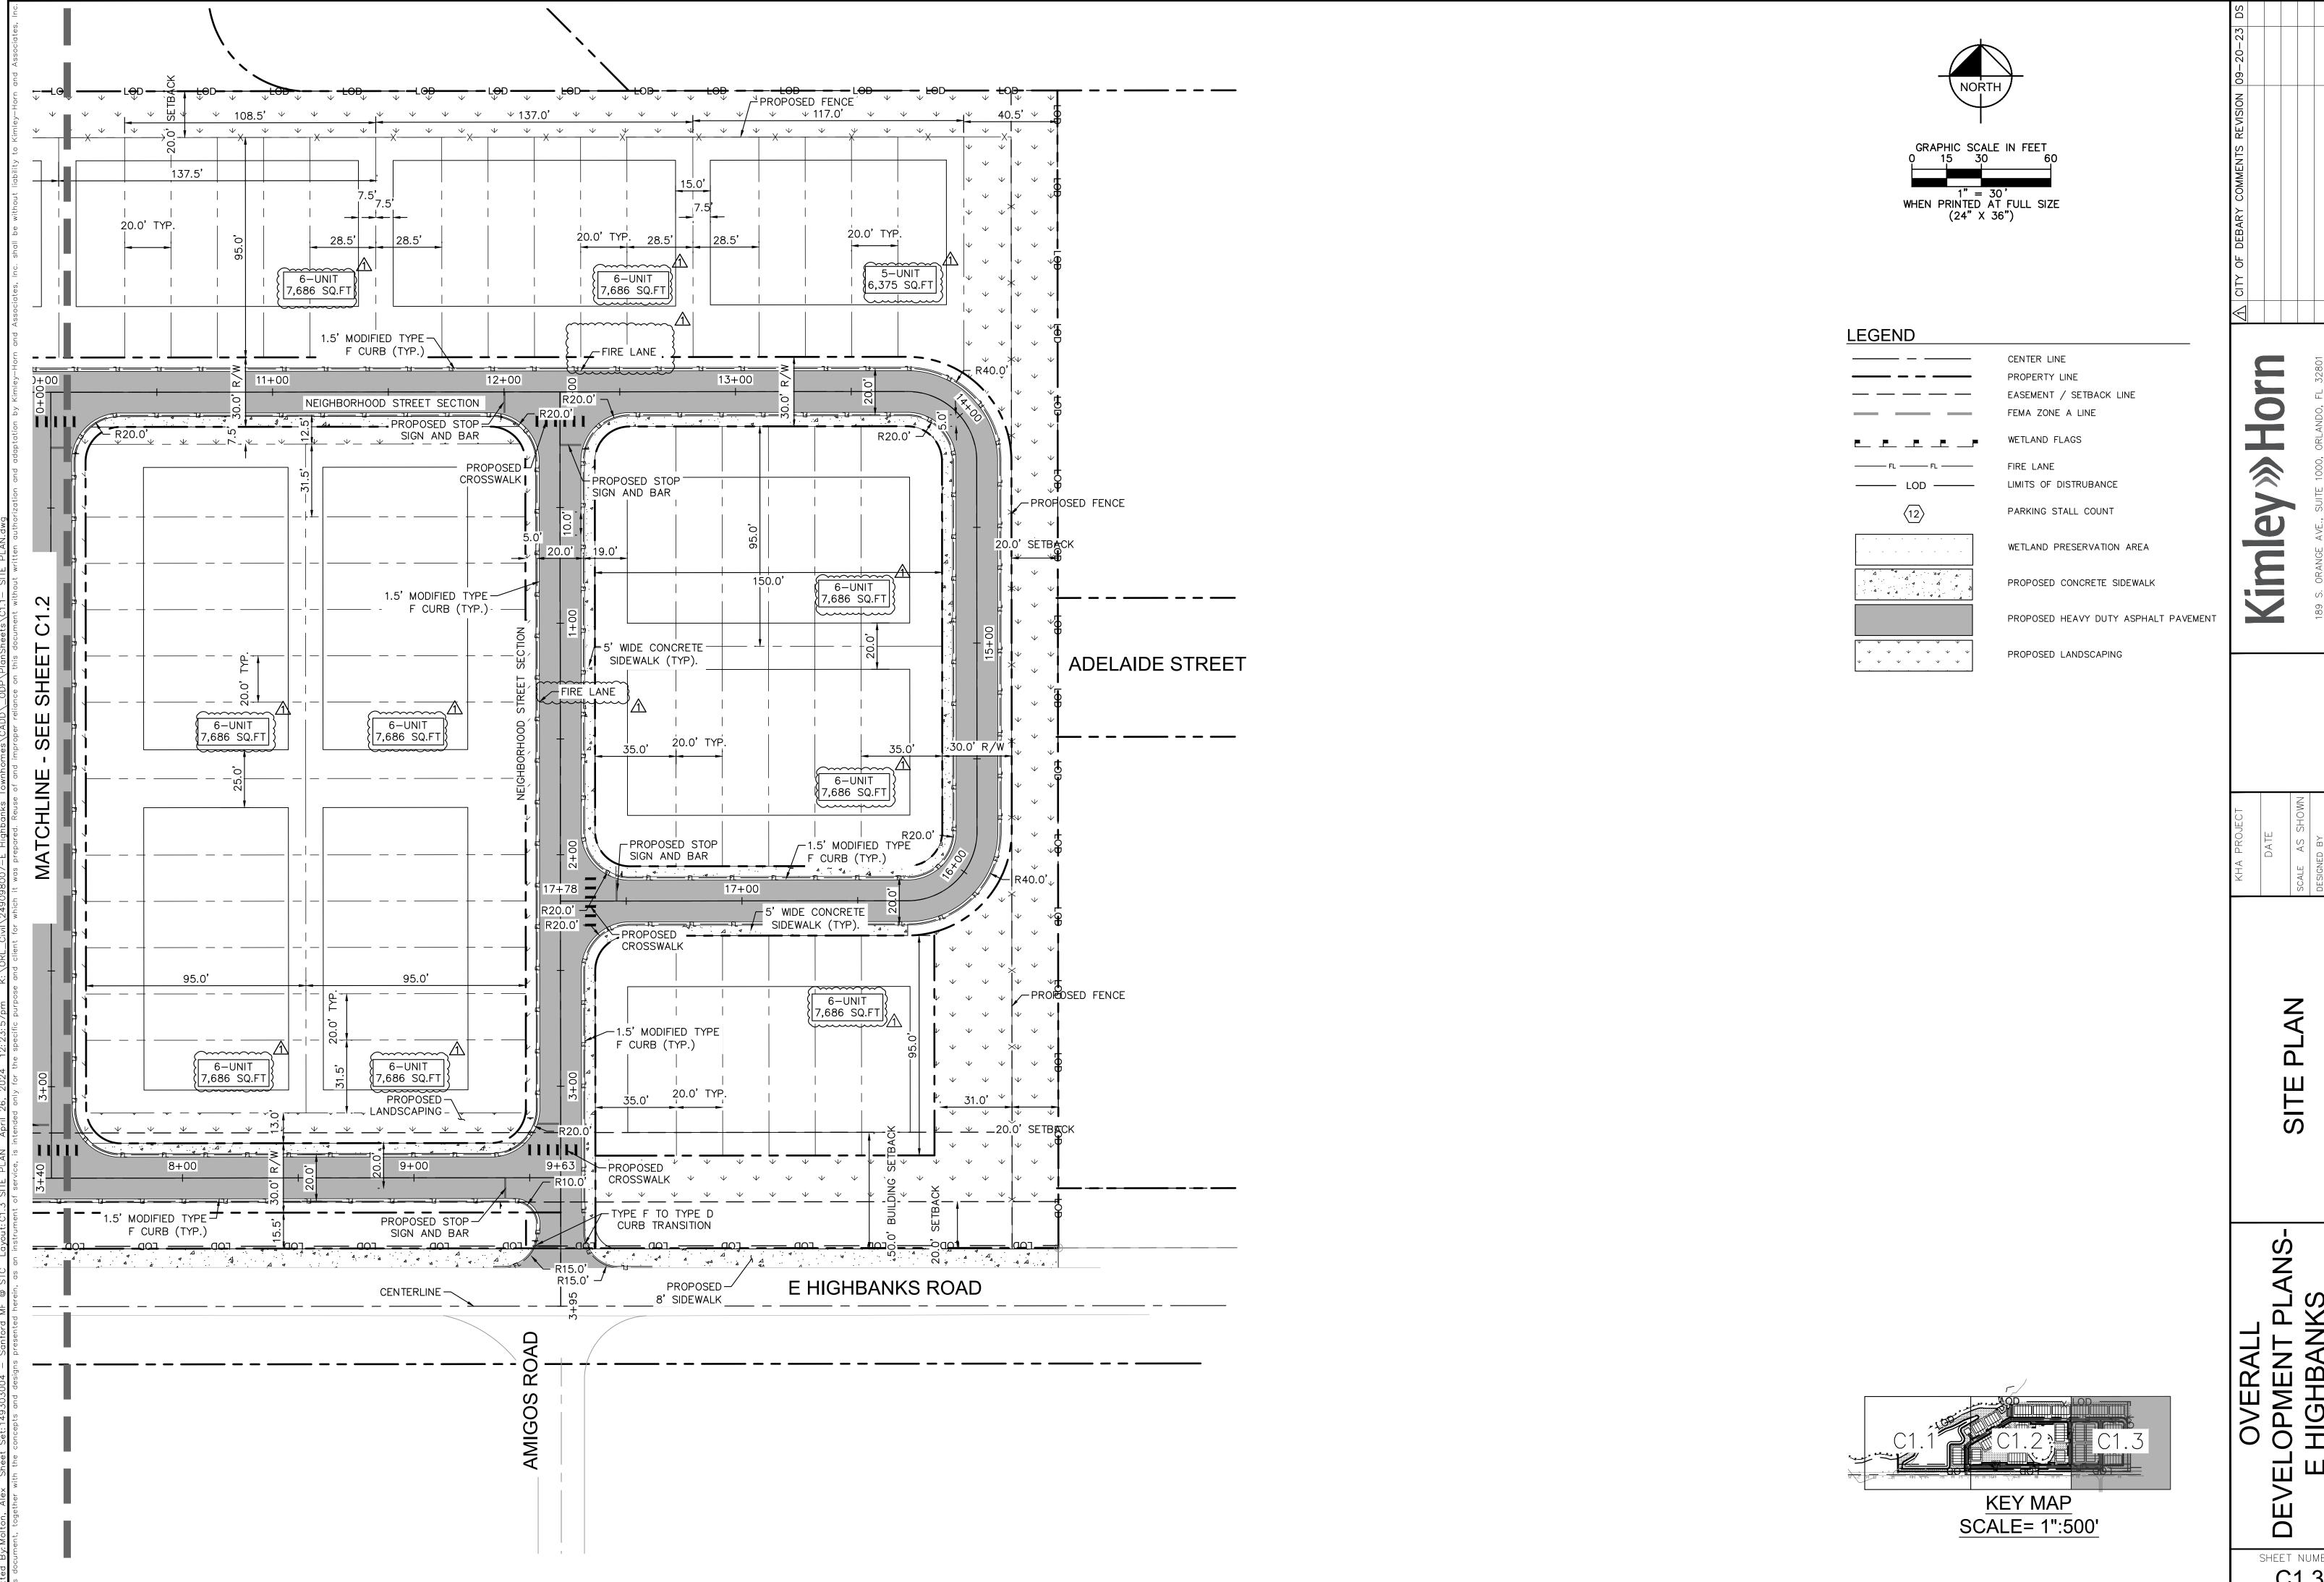

SHEET NUMBER C1.3

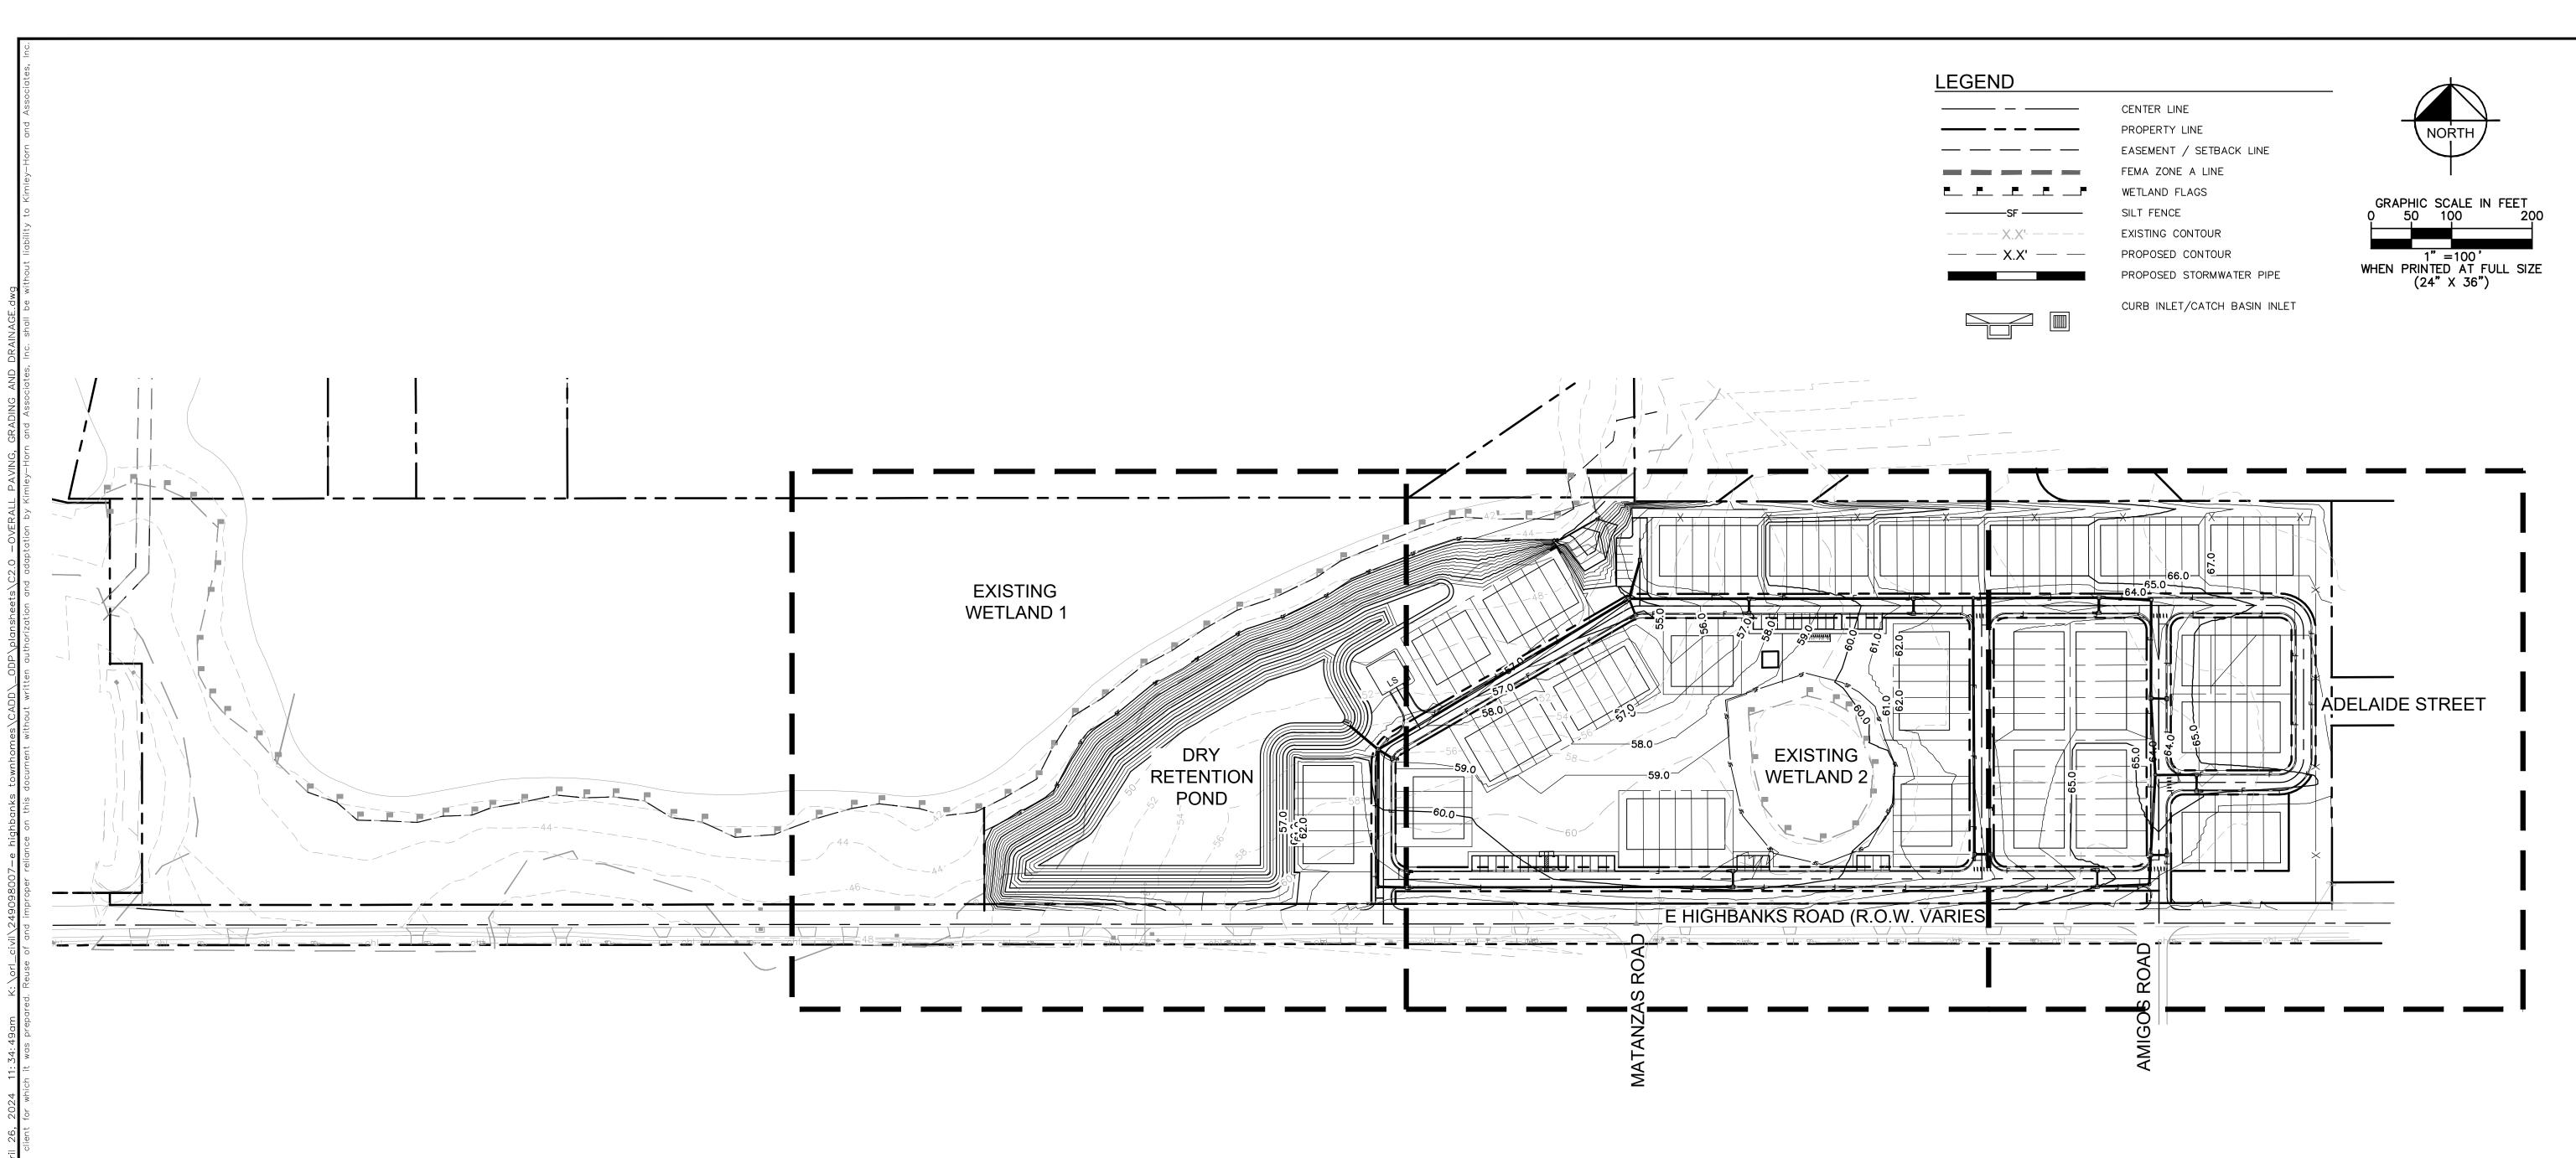


GENERAL NOTES

THIS INFORMATION IS PROVIDED TO YOU AT THE REQUEST OF OUR CLIENT AND IS SOLELY FOR YOUR INFORMATION AND CONVENIENCE. THESE PLANS ARE PRELIMINARY ONLY AND SUBJECT TO SIGNIFICANT REVISION BEFORE CONSTRUCTION PLANS ARE ISSUED. NEITHER KIMLEY—HORN'S CLIENT WILL BE RESPONSIBLE FOR ANY LOSSES OR COSTS ASSOCIATED WITH RELIANCE ON THIS PRELIMINARY INFORMATION OR CHANGES IN THE INFORMATION PRIOR TO FINAL DESIGN.

- MASTER STORMWATER SYSTEM WILL BE DESIGNED AND PERMITTED AS PART OF THE CONSTRUCTION PLAN
- 2. LOT GRADING WILL BE INCLUDED AS PART OF THE CONSTRUCTION PLAN REVIEW AS WELL AS FINISHED FLOOR ELEVATIONS.
- STORMWATER CRITERIA WILL BE CONSISTENT WITH THE ST. JOHNS RIVER WATER MANAGEMENT DISTRICT AND THE CITY OF DEBARY REQUIREMENTS.


 DRY STORMWATER SIZE AND AREA TO BE DETERMINED DURING MASS GRADING, STORMWATER DESIGN, AND PERMITTING.

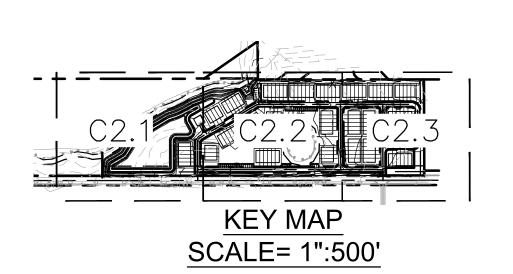



OVERALL PAVING GRADING AND DRAINAGE

OVERALL
DEVELOPMENT PLA
E HIGHBANKS
TOWNHOMES

SHEET NUMBER C2.0

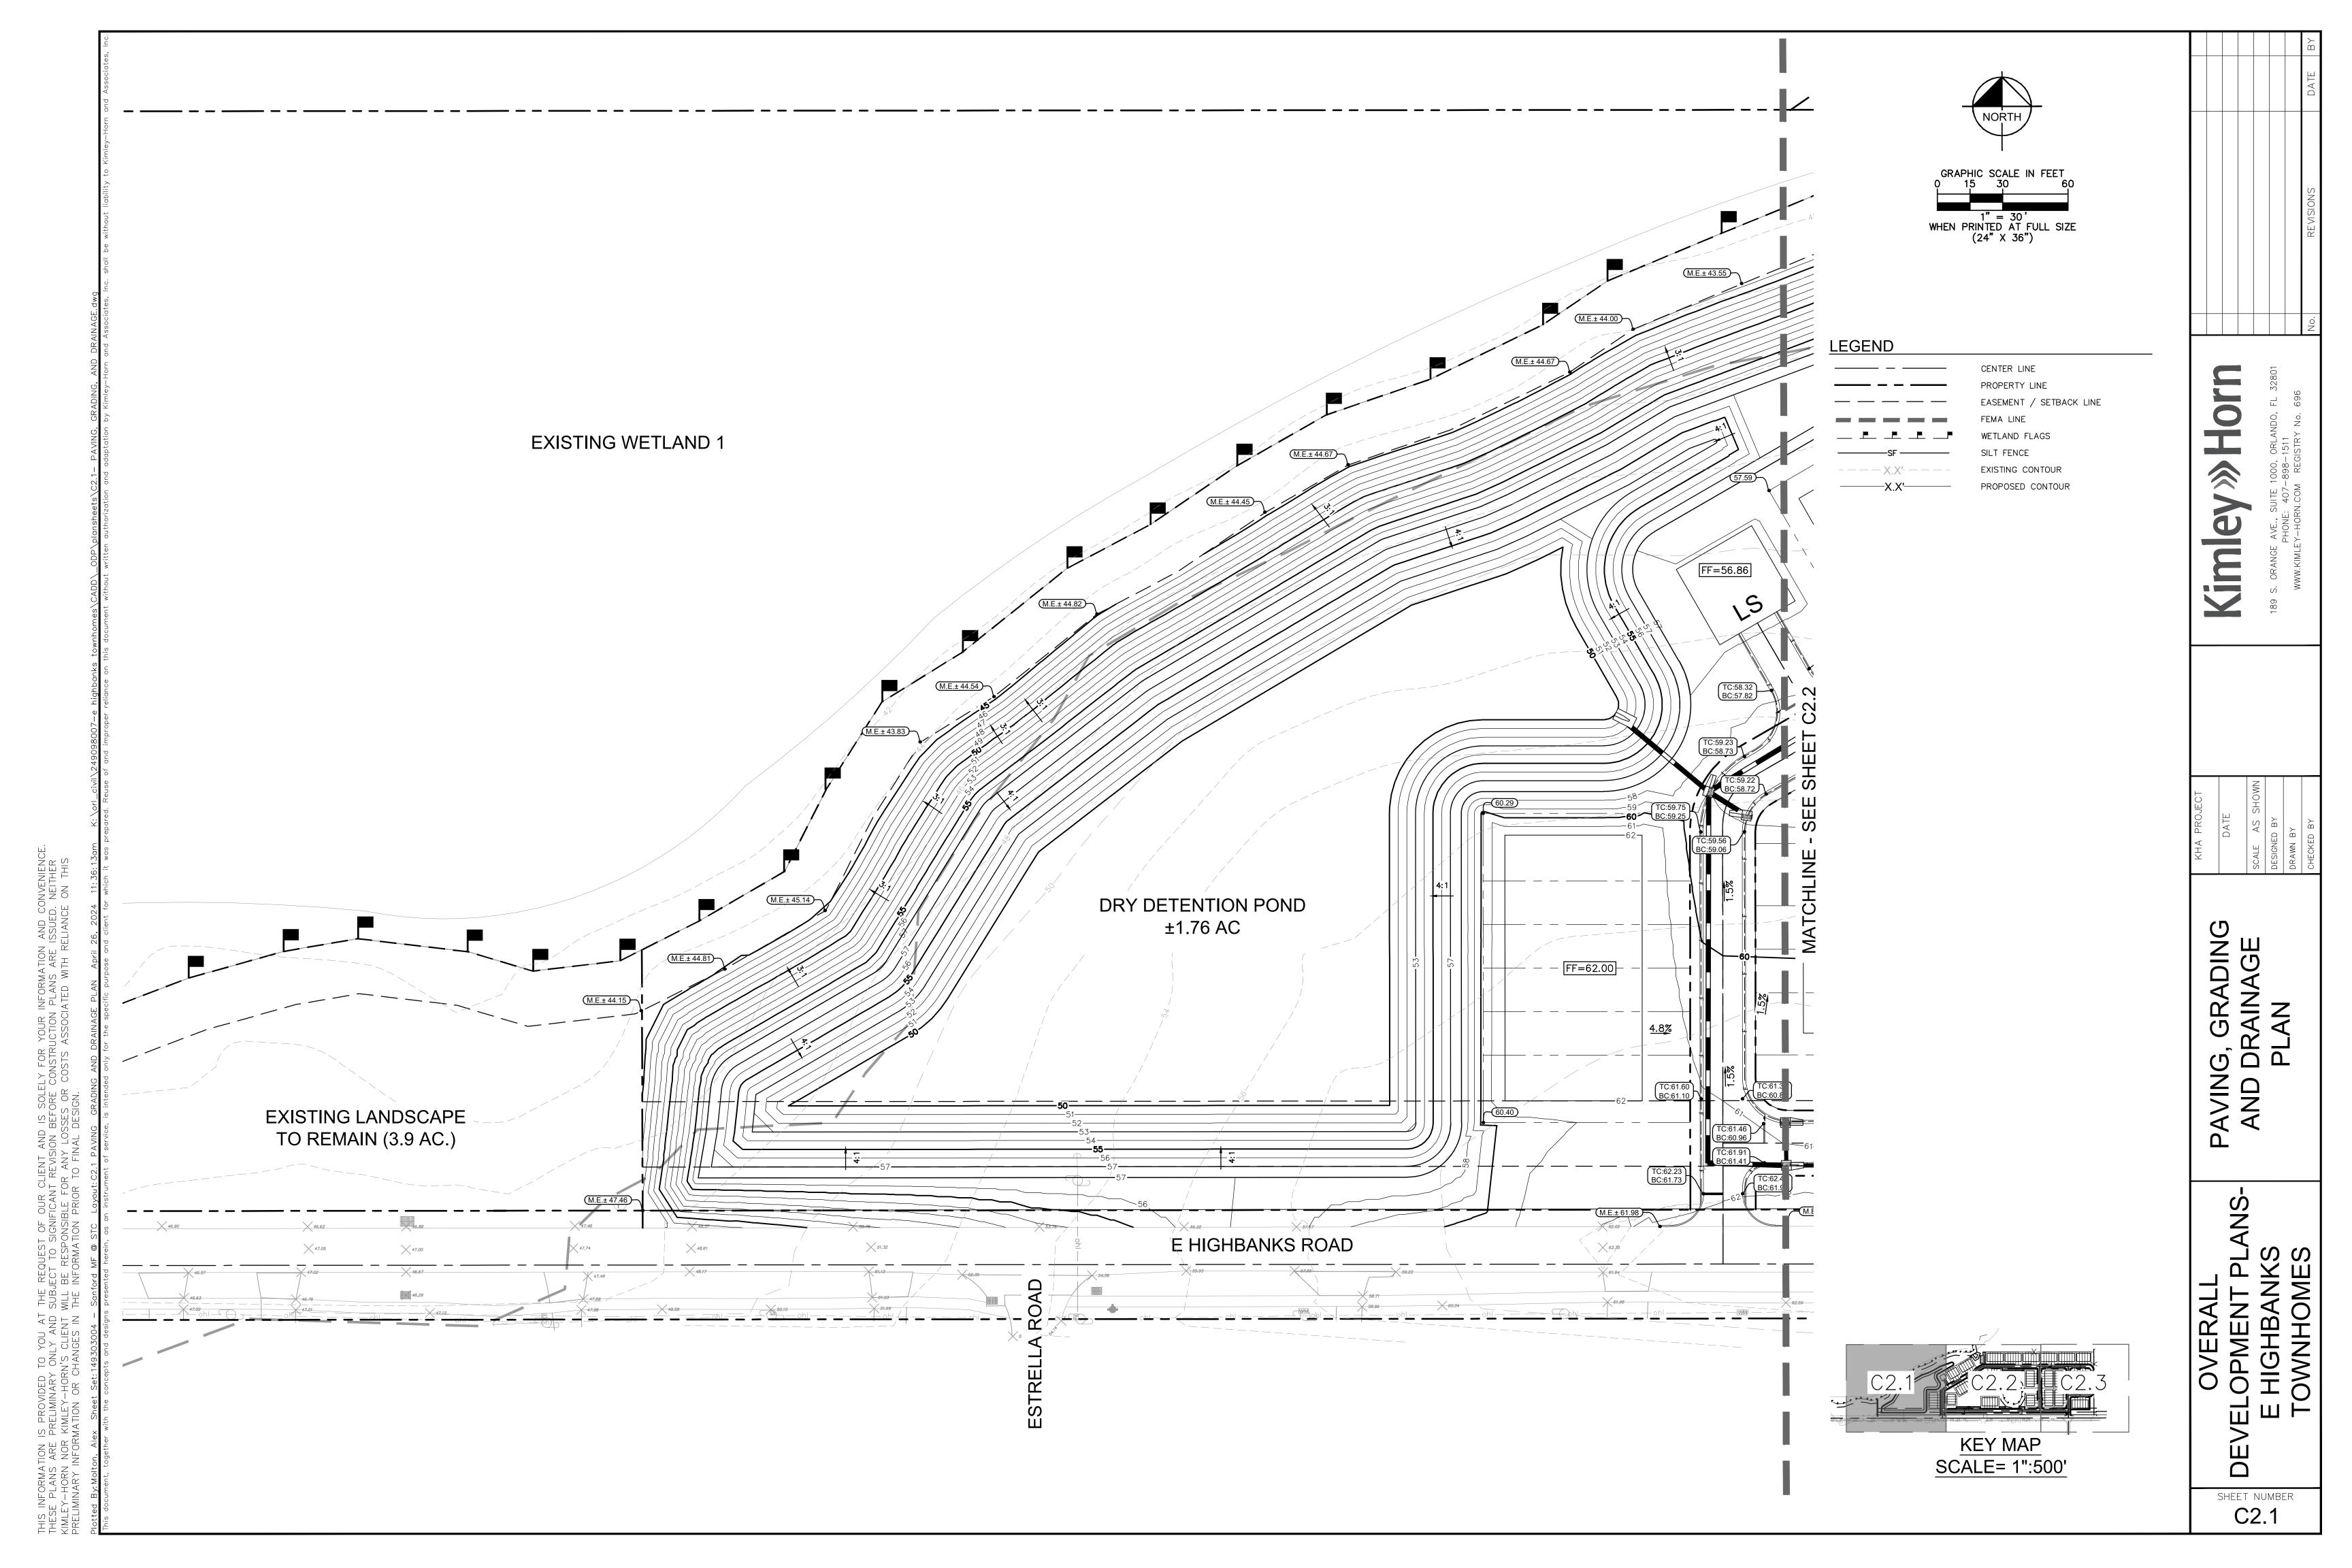

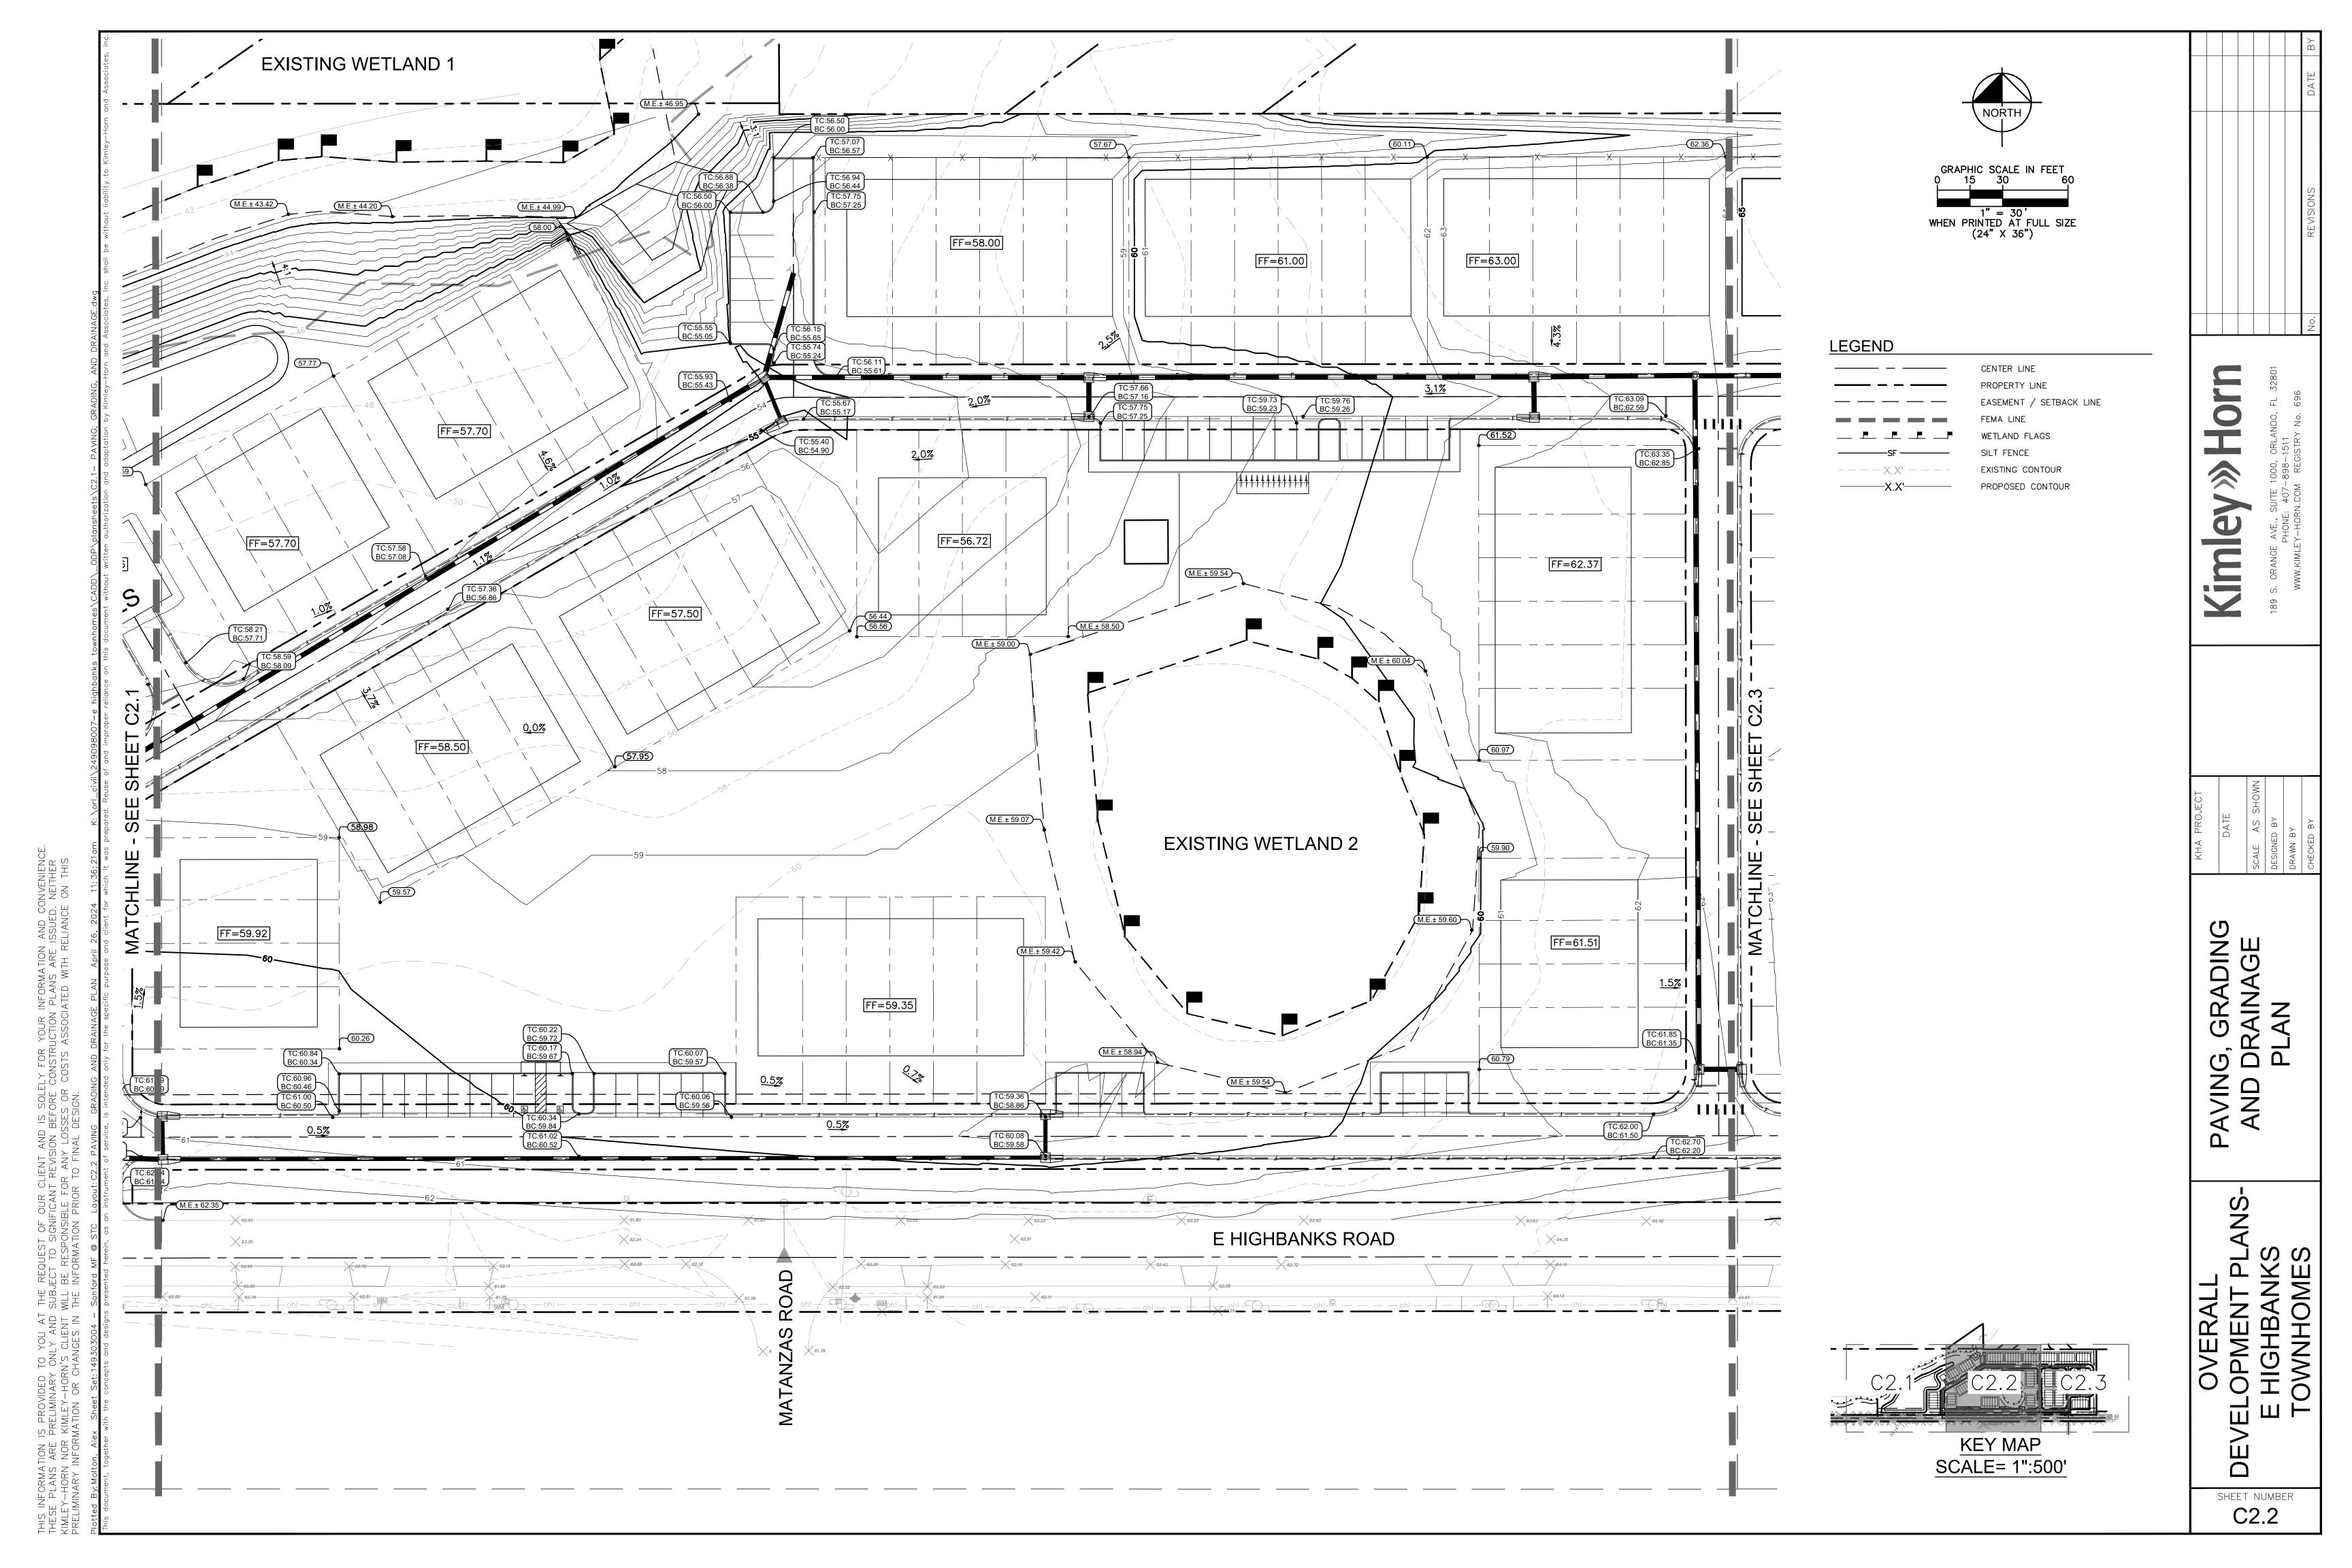


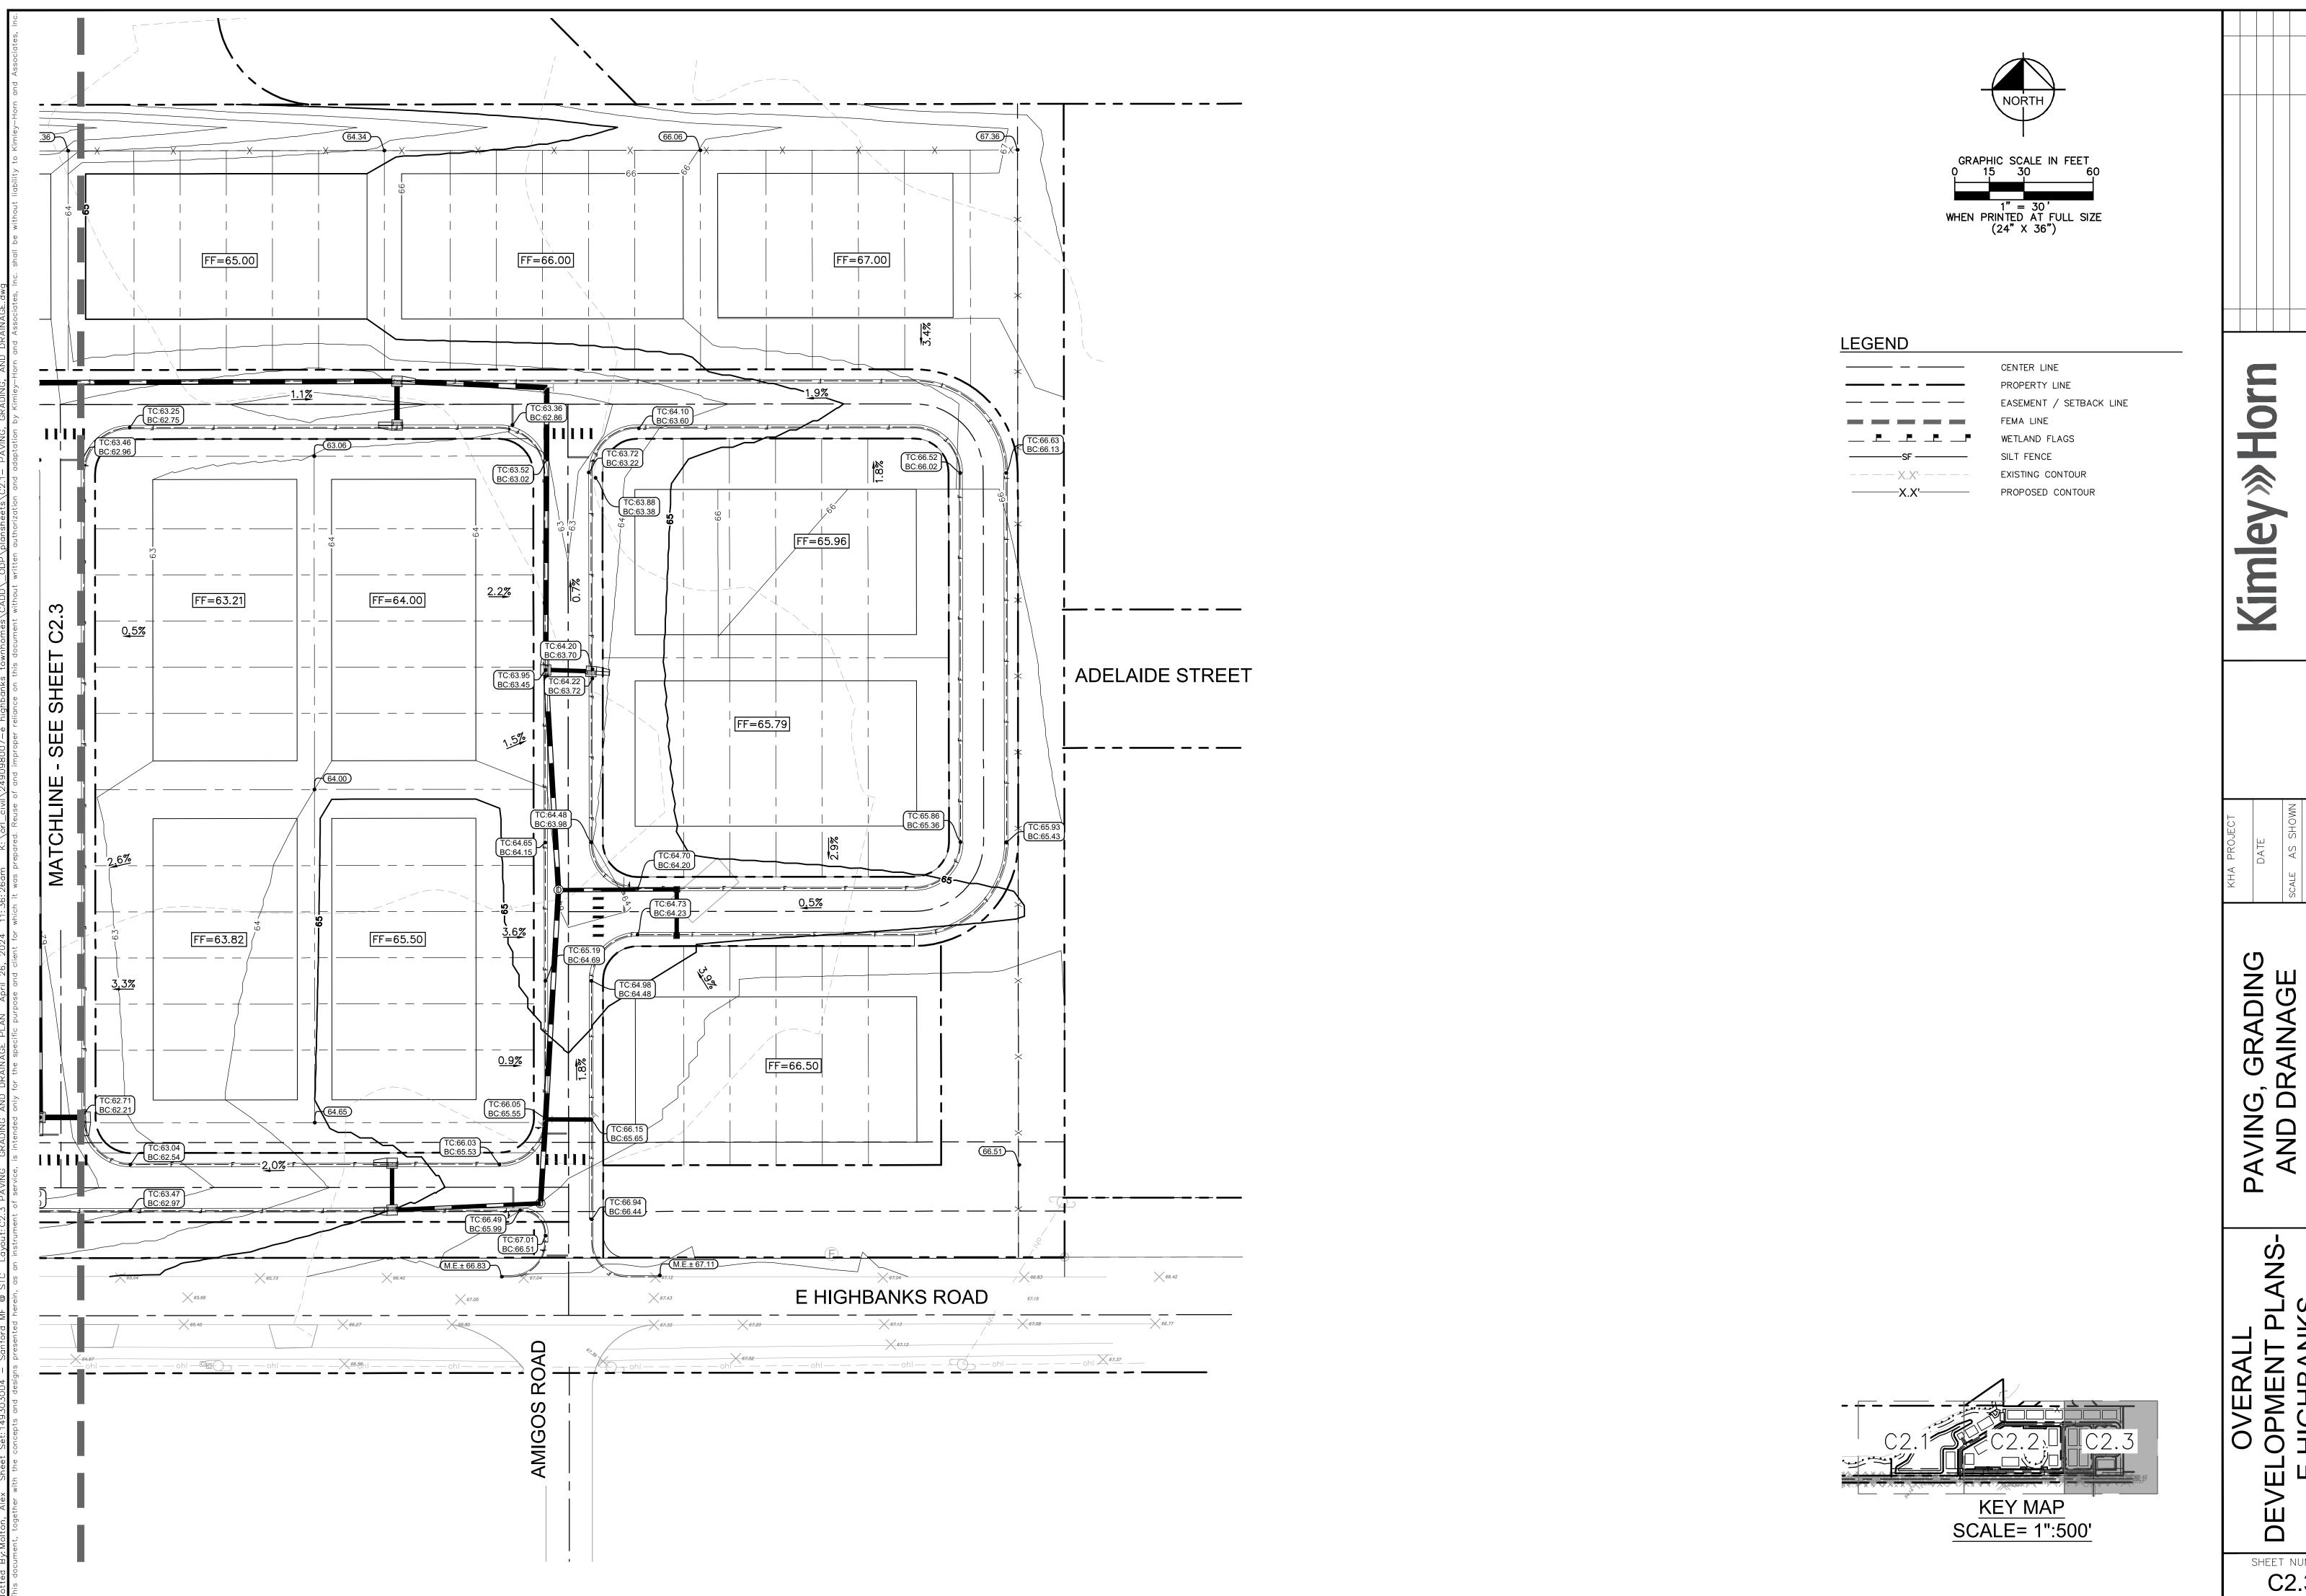

JG, GRADING DRAINAGE PLAN

E HIGHBANKS TOWNHOMES

SHEET NUMBER C2.3

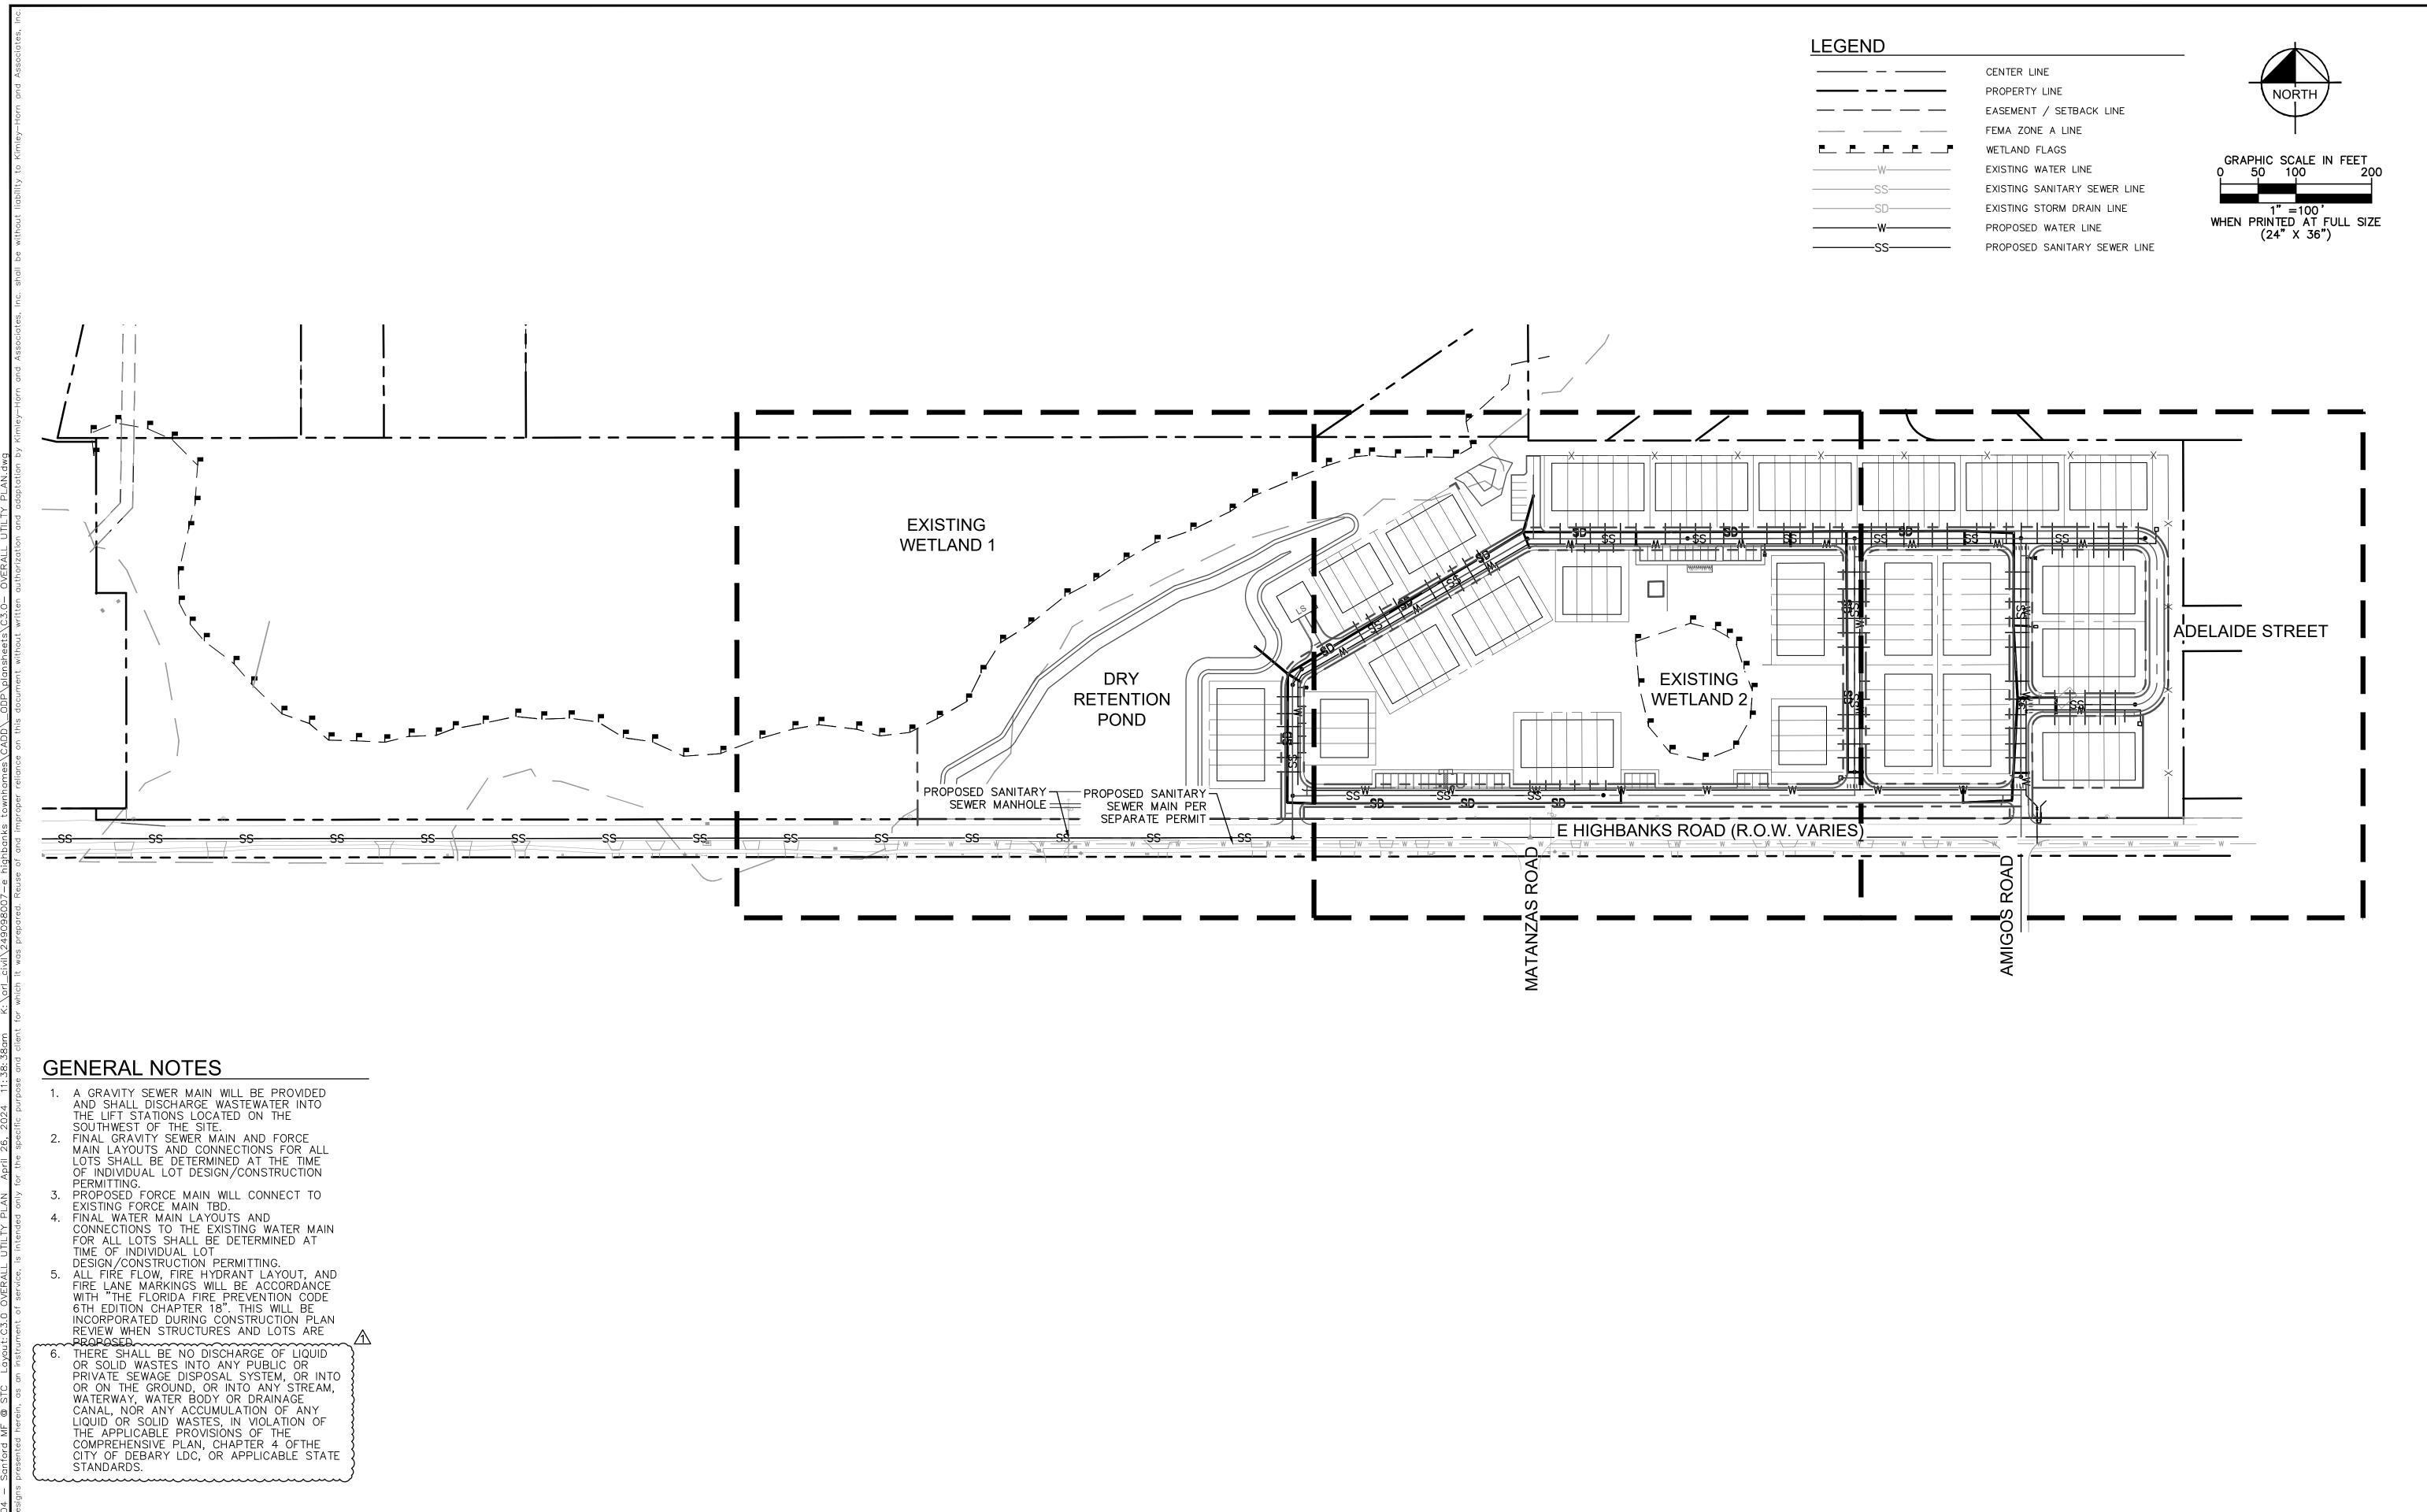

YOUR INFORMATION AND CONVENIENC UCTION PLANS ARE ISSUED. NEITHER ASSOCIATED WITH RELIANCE ON THIS

SOLELY FOR FORE CONSTRU SOR COSTS A

I IS PROVIDED TO YOU AT TE PRELIMINARY ONLY AND SERMILEY—HORN'S CLIENT WORMATION OR CHANGES IN TE

OVERALL
'ELOPMENT PLA
E HIGHBANKS
TOWNHOMES

ALL UPLAN


RALL


Ш


C3.0

Ш SHEET NUMBER


KEY MAP SCALE= 1":500'

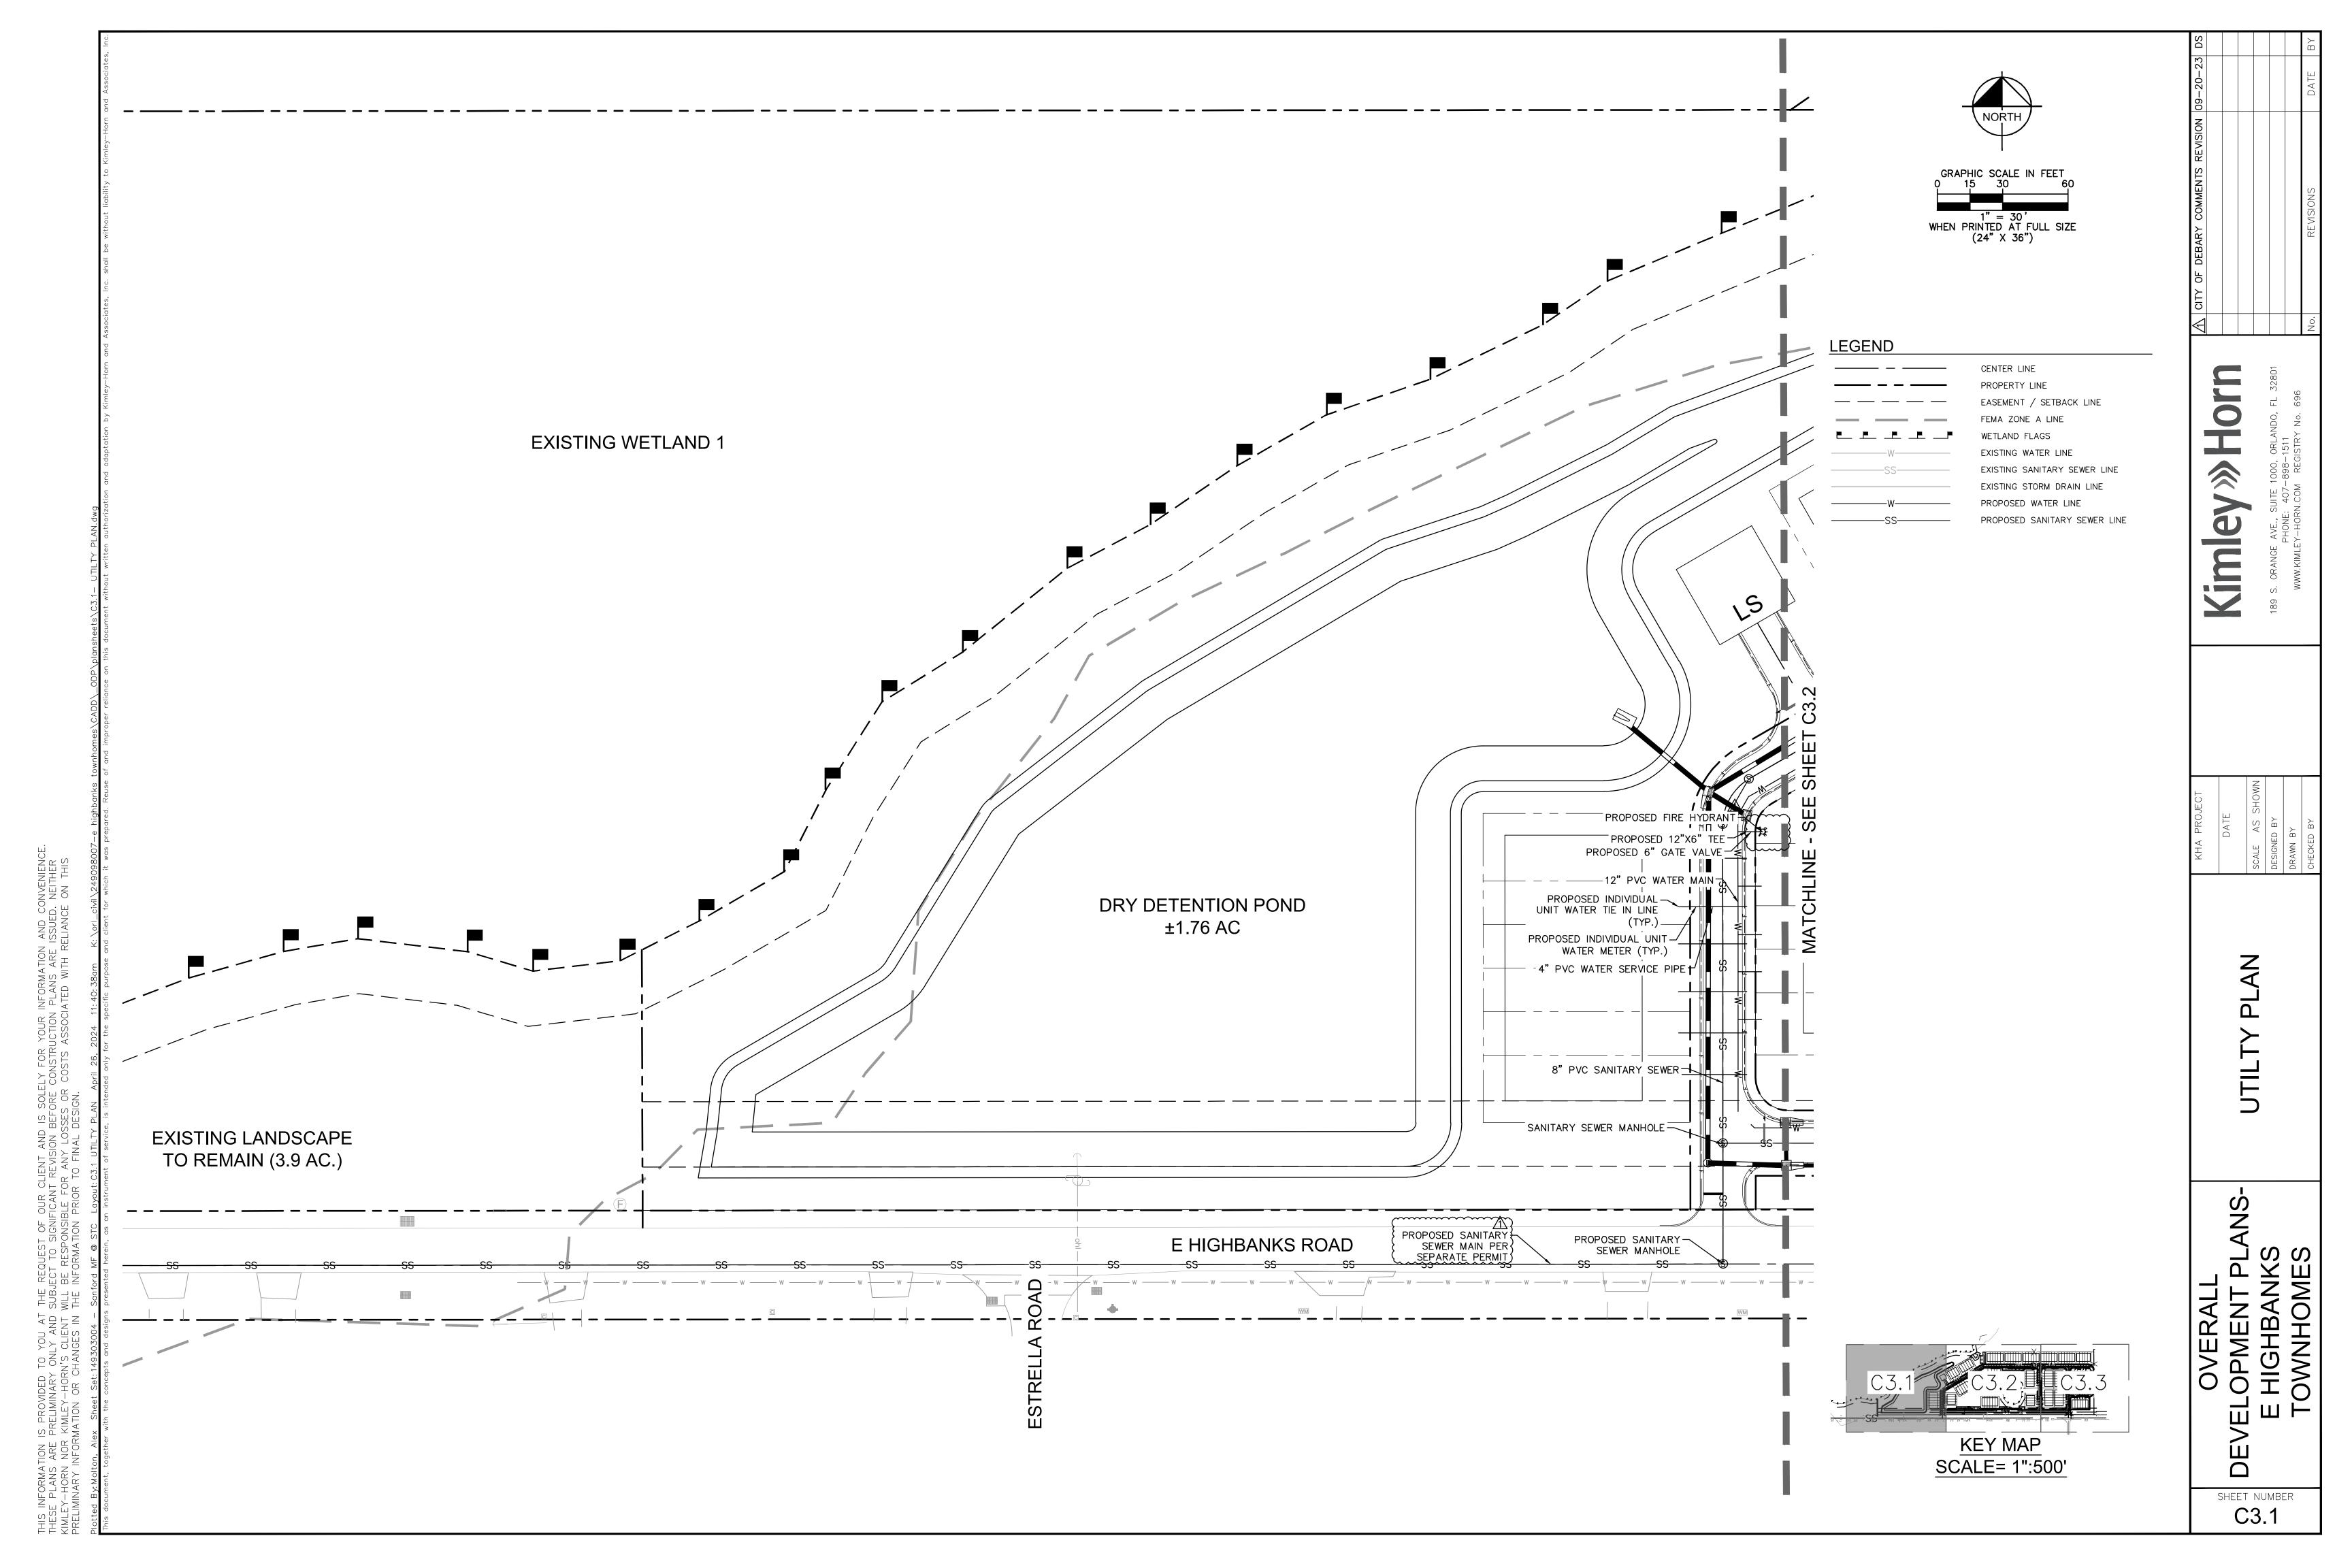

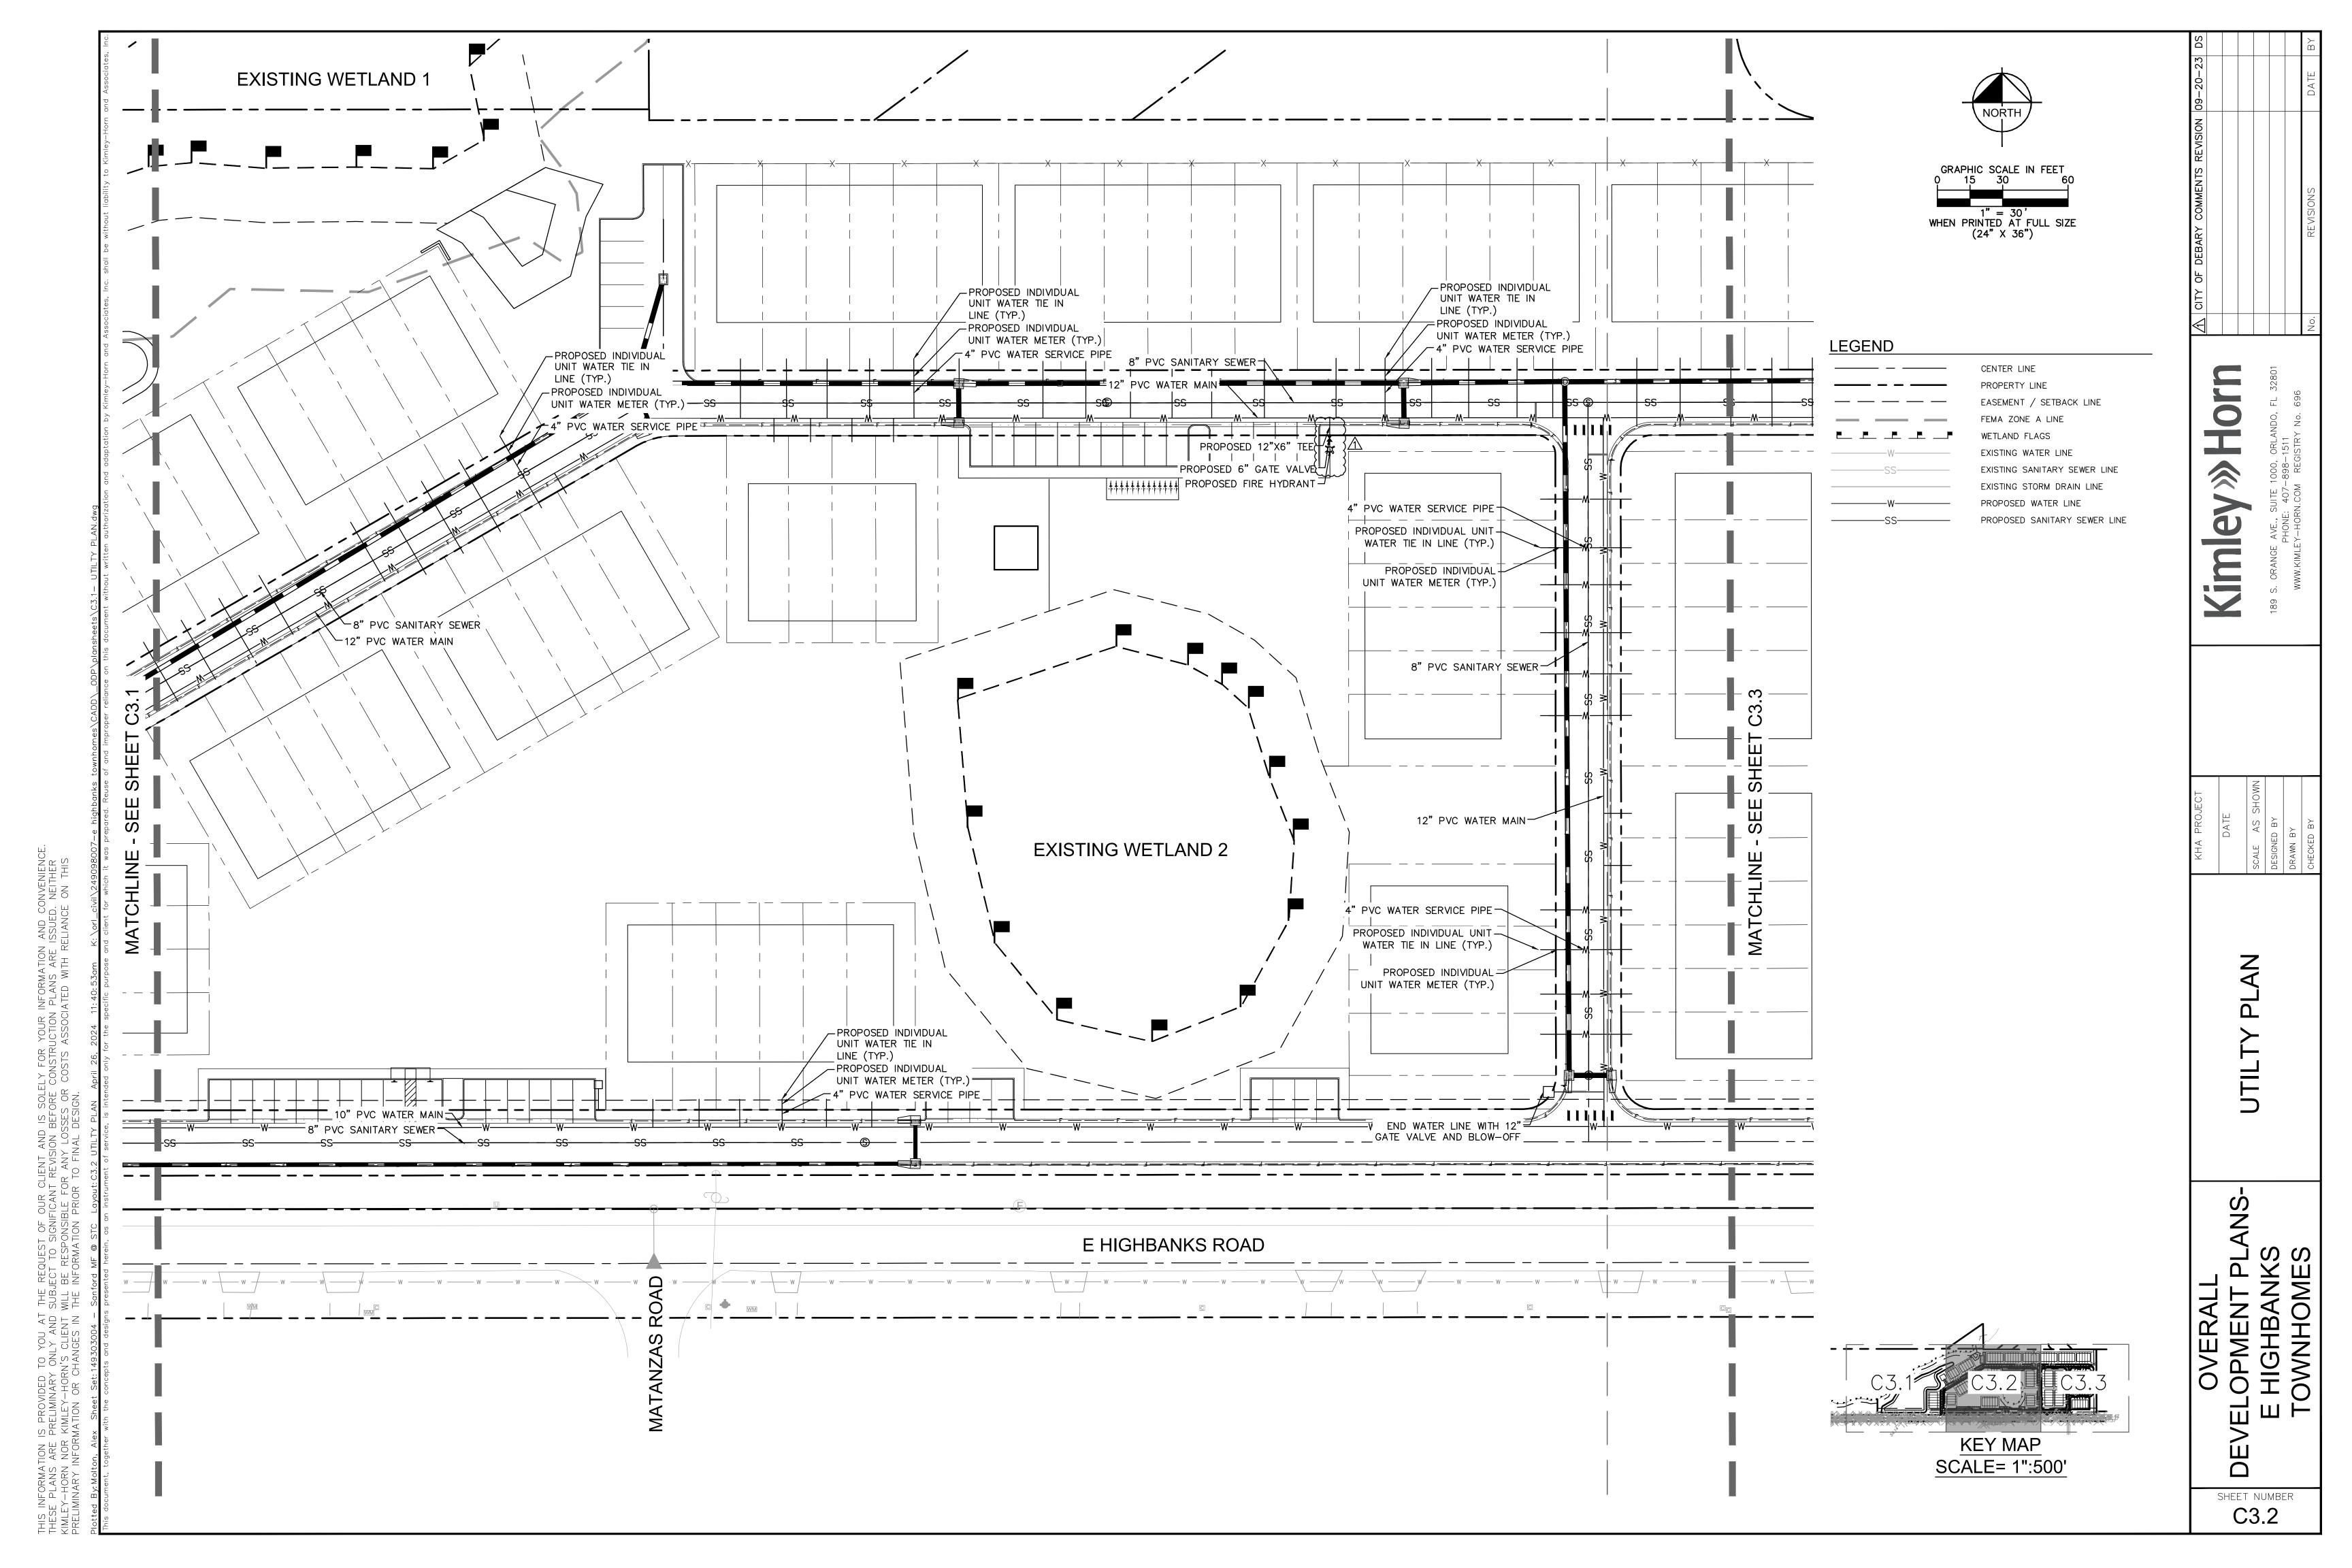

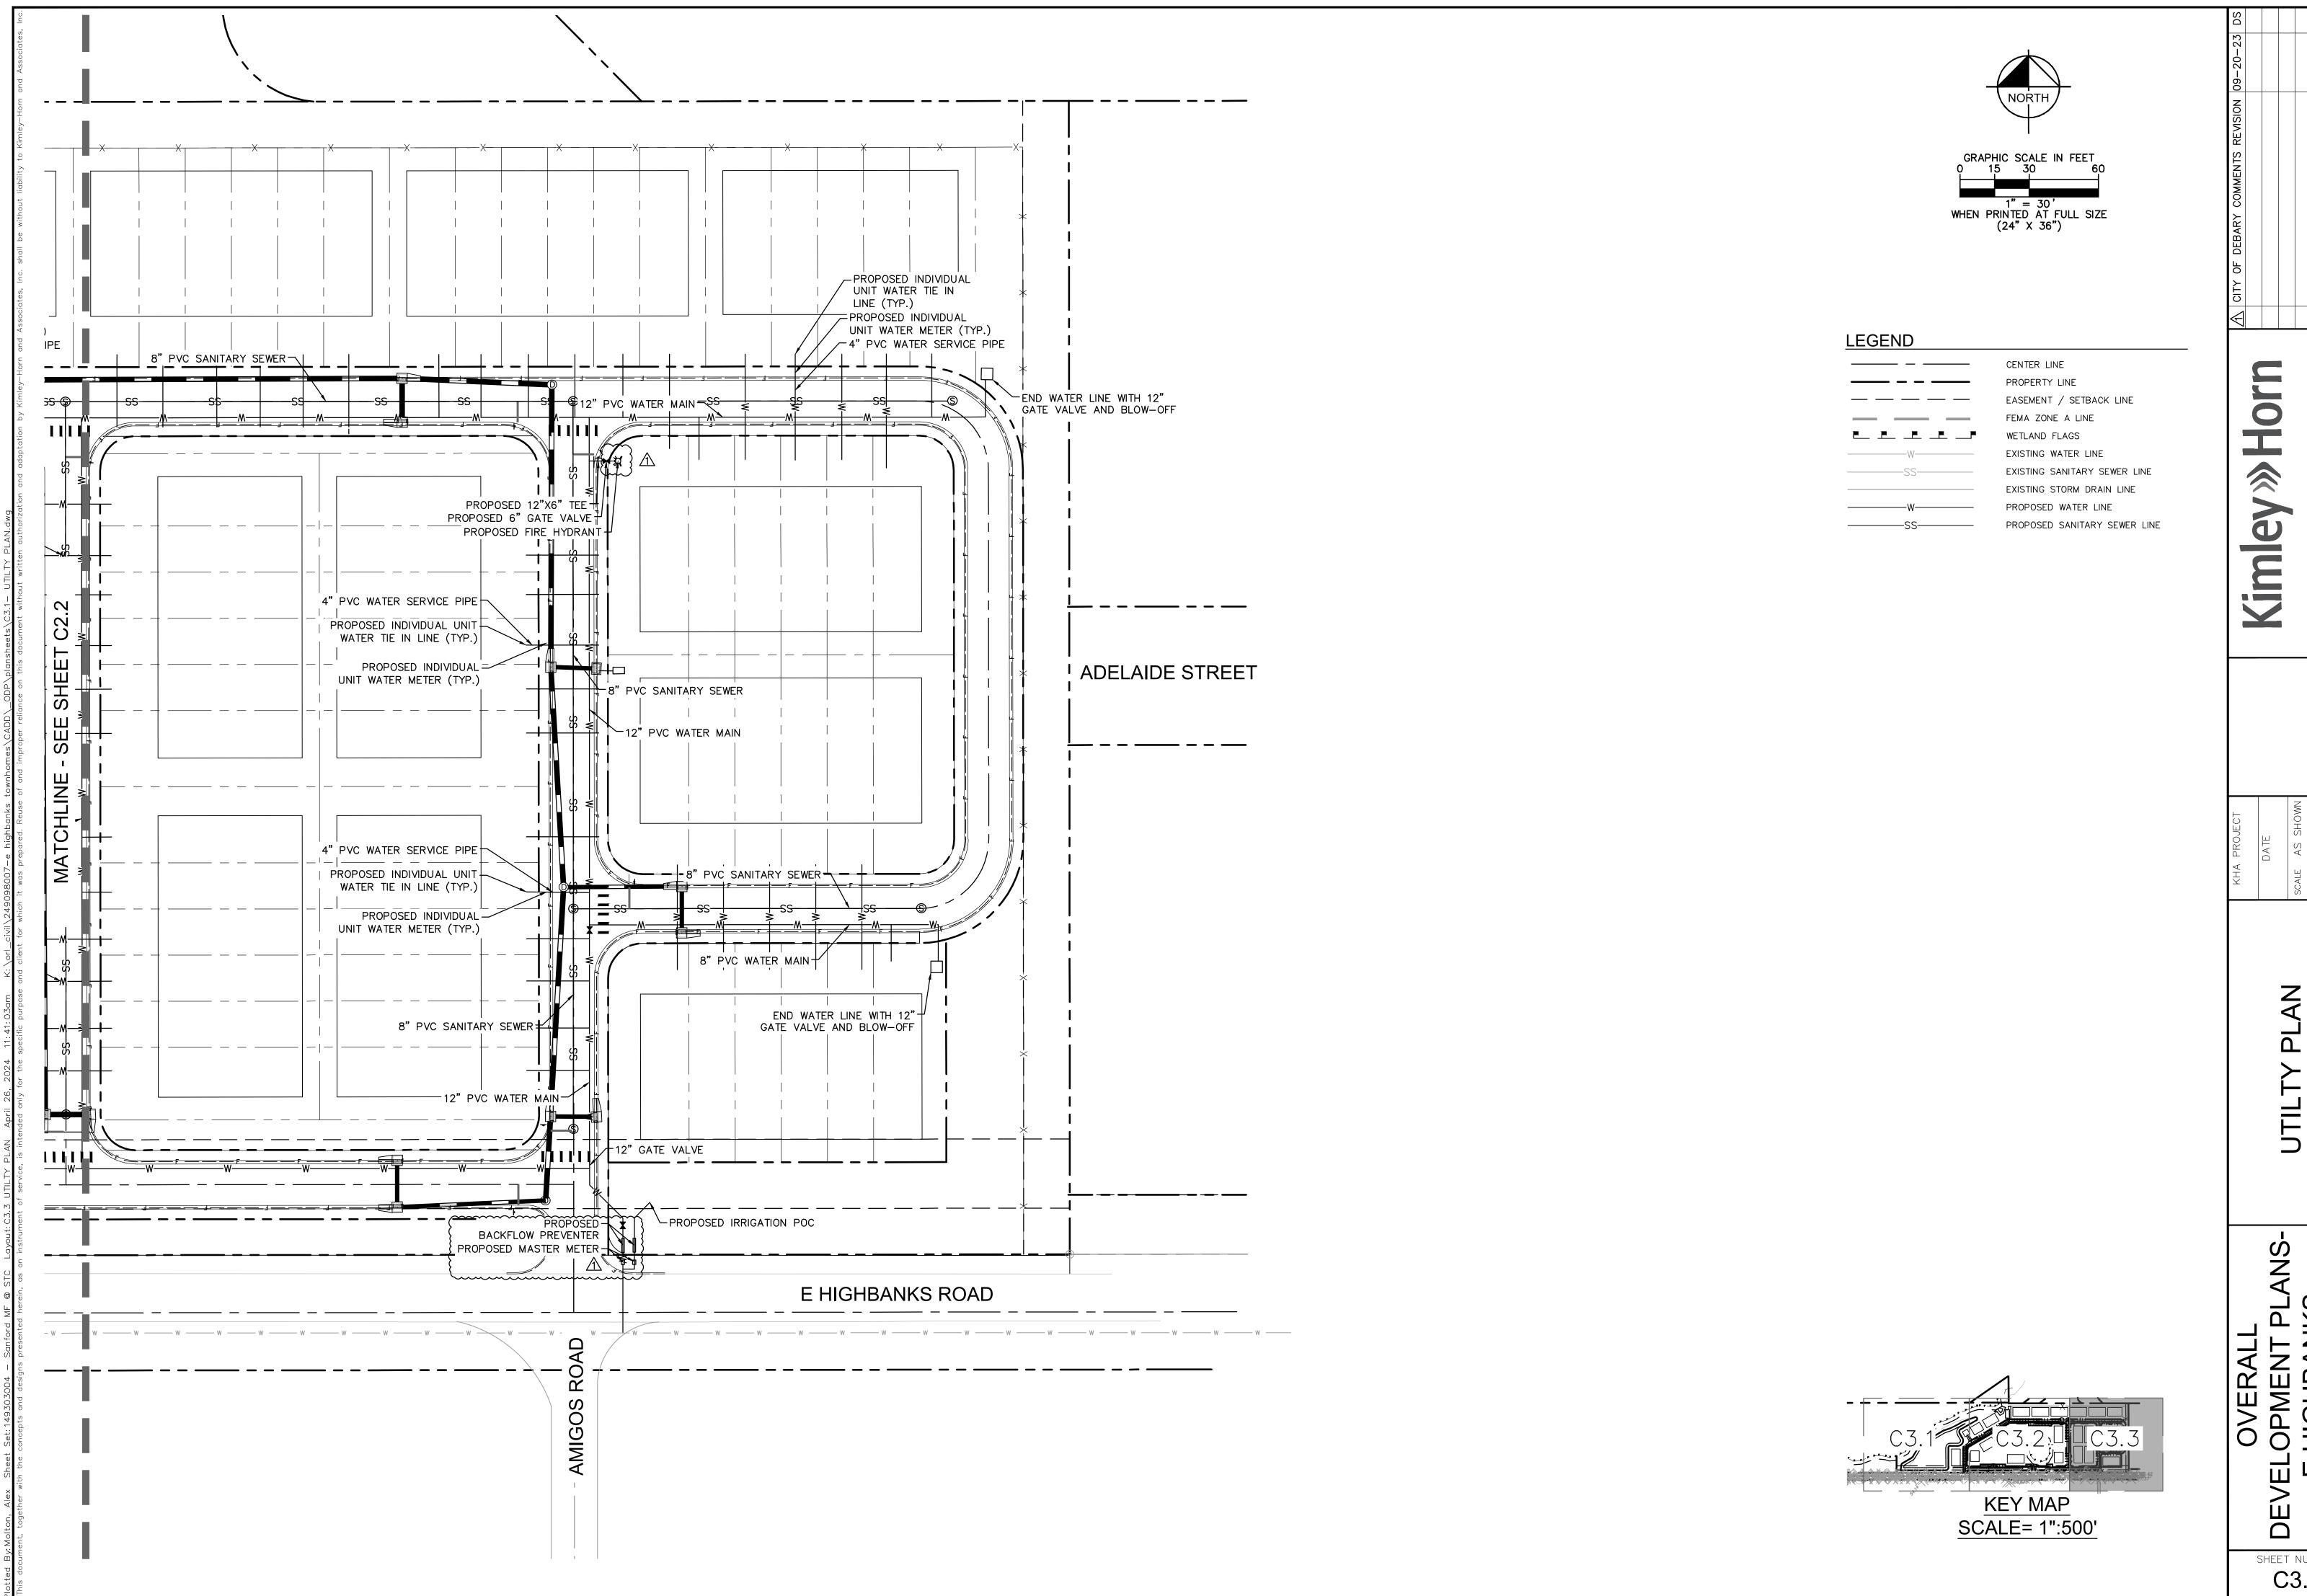


SHEET NUMBER C3.3

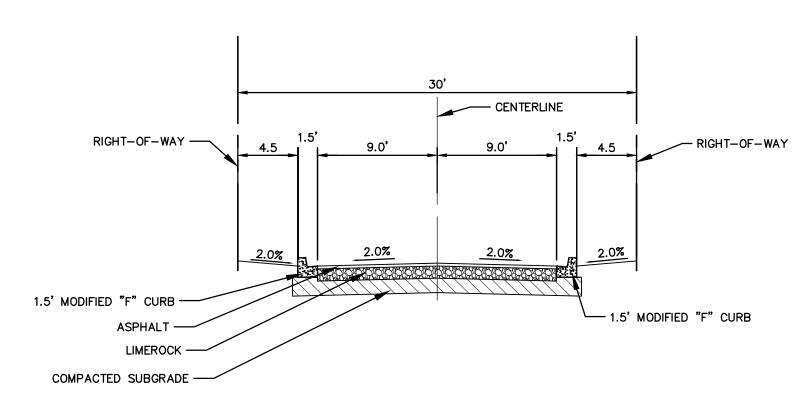

TYPICAL NEIGHBORHOOD STREET SECTION-1

N.T.S.
PUBLIC ROAD / ROW
(FRONT LOADED LOTS)

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TYPICAL NEIGHBORHOOD STREET SECTION-2

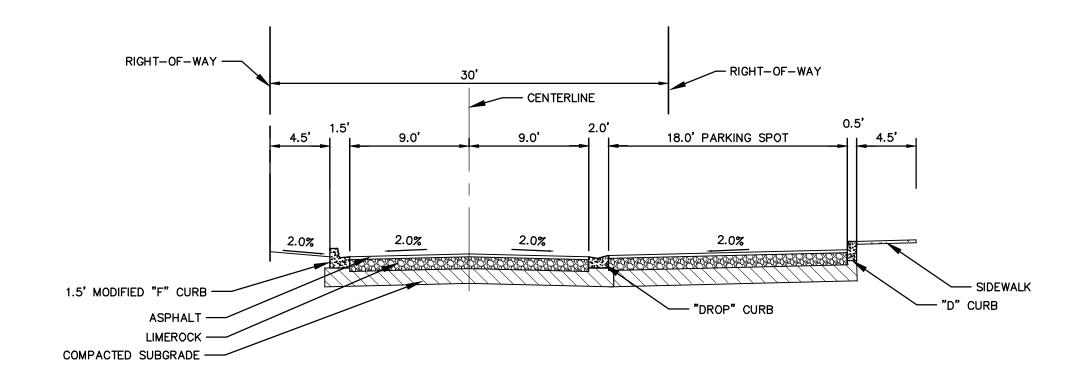N.T.S. PUBLIC ROAD / ROW (FRONT LOADED LOTS) 189 S. ORANGE AVE., SUITE 1000, ORLANDO, FL 328
PHONE: 407-898-1511


WWW.KIMLEY-HORN.COM REGISTRY No. 696

DATE
SCALE AS SHOWN
DESIGNED BY

YPICAL SECTIONS

EVELOPMENT PLANS E HIGHBANKS TOWNHOMES

SHEET NUMBER C4.0

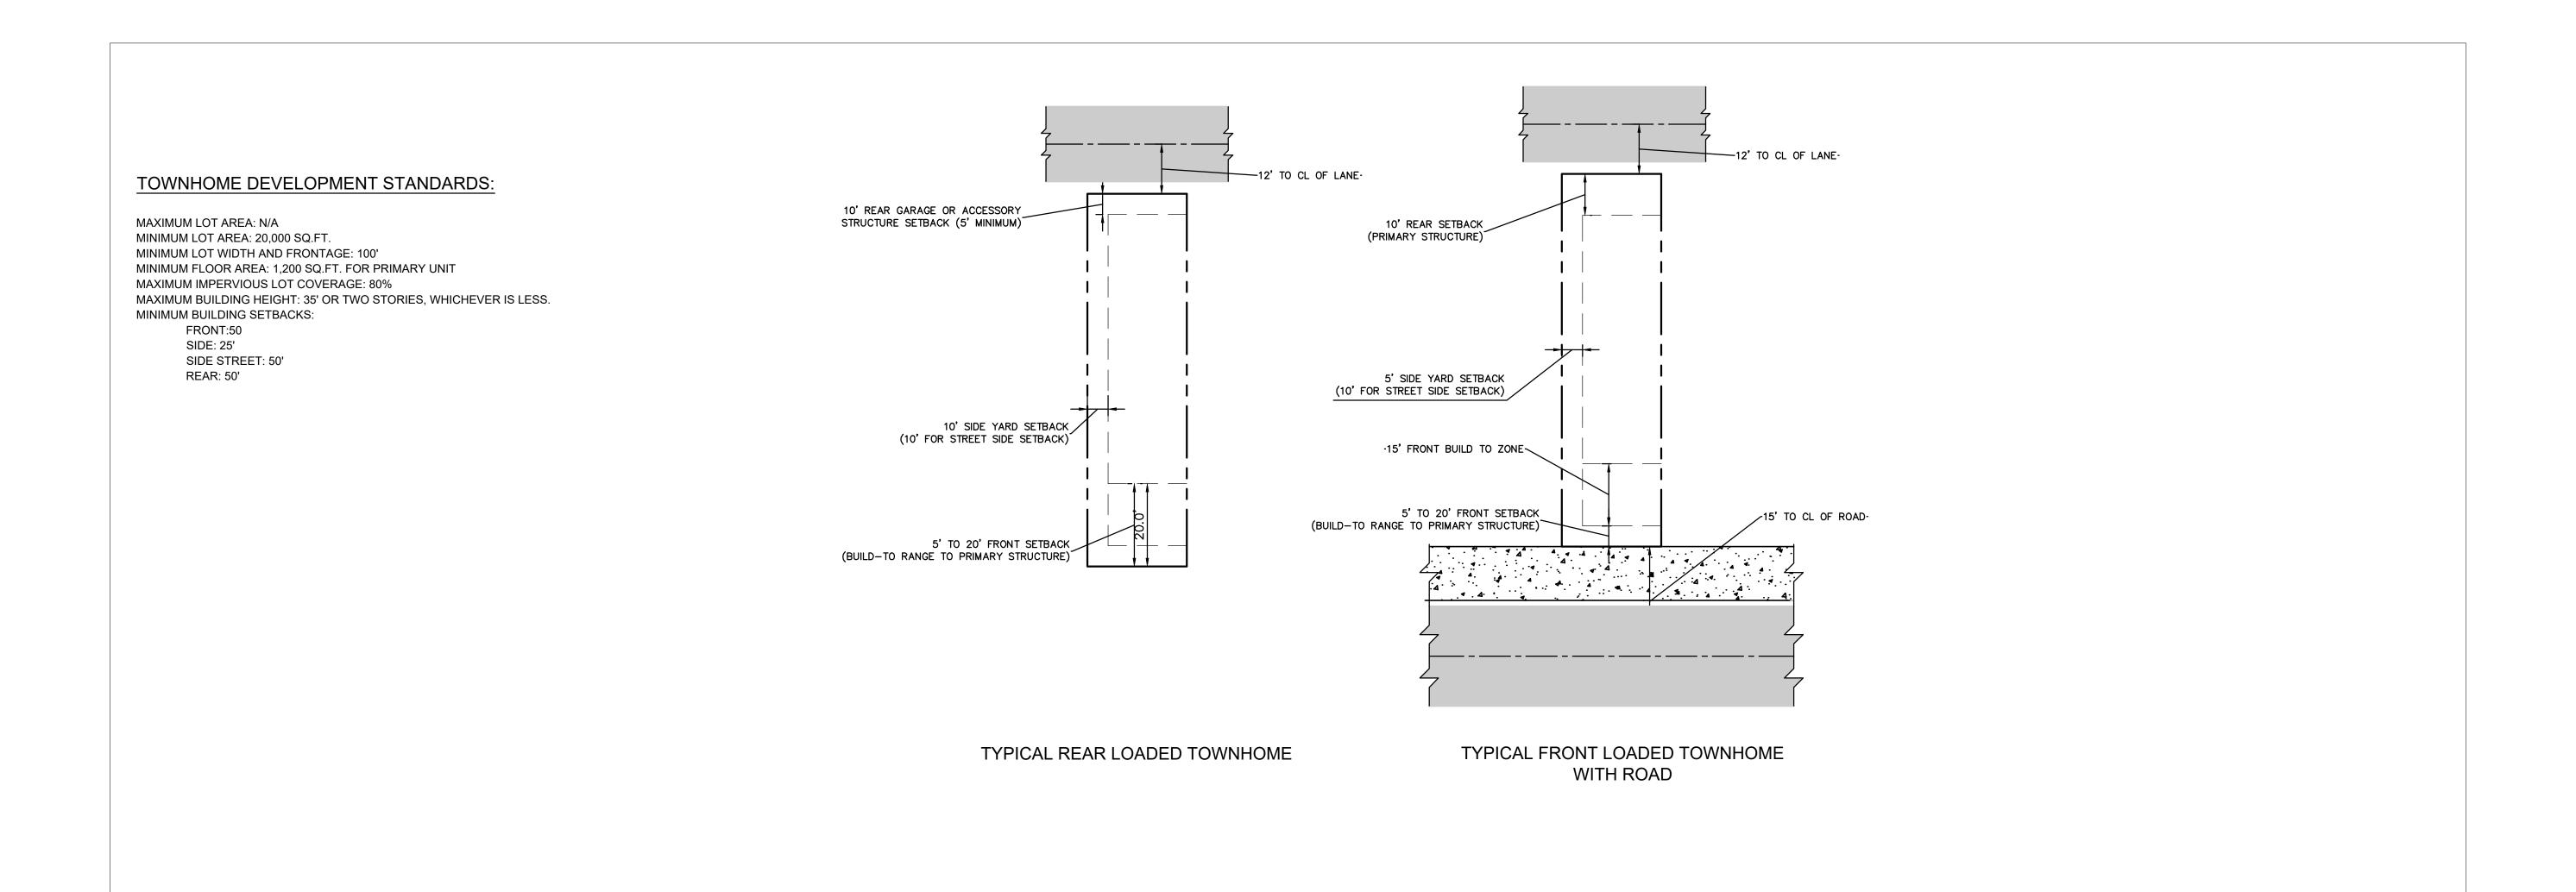

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SHOWN

189 S. ORANGE AVE., SUITE 1

PHONE: 407—


WWW.KIMLEY—HORN.COM

LOT DIMENSIONS

OVERALL
DEVELOPMENT PLANSE HIGHBANKS
TOWNHOMES


SHEET NUMBER


C5.0

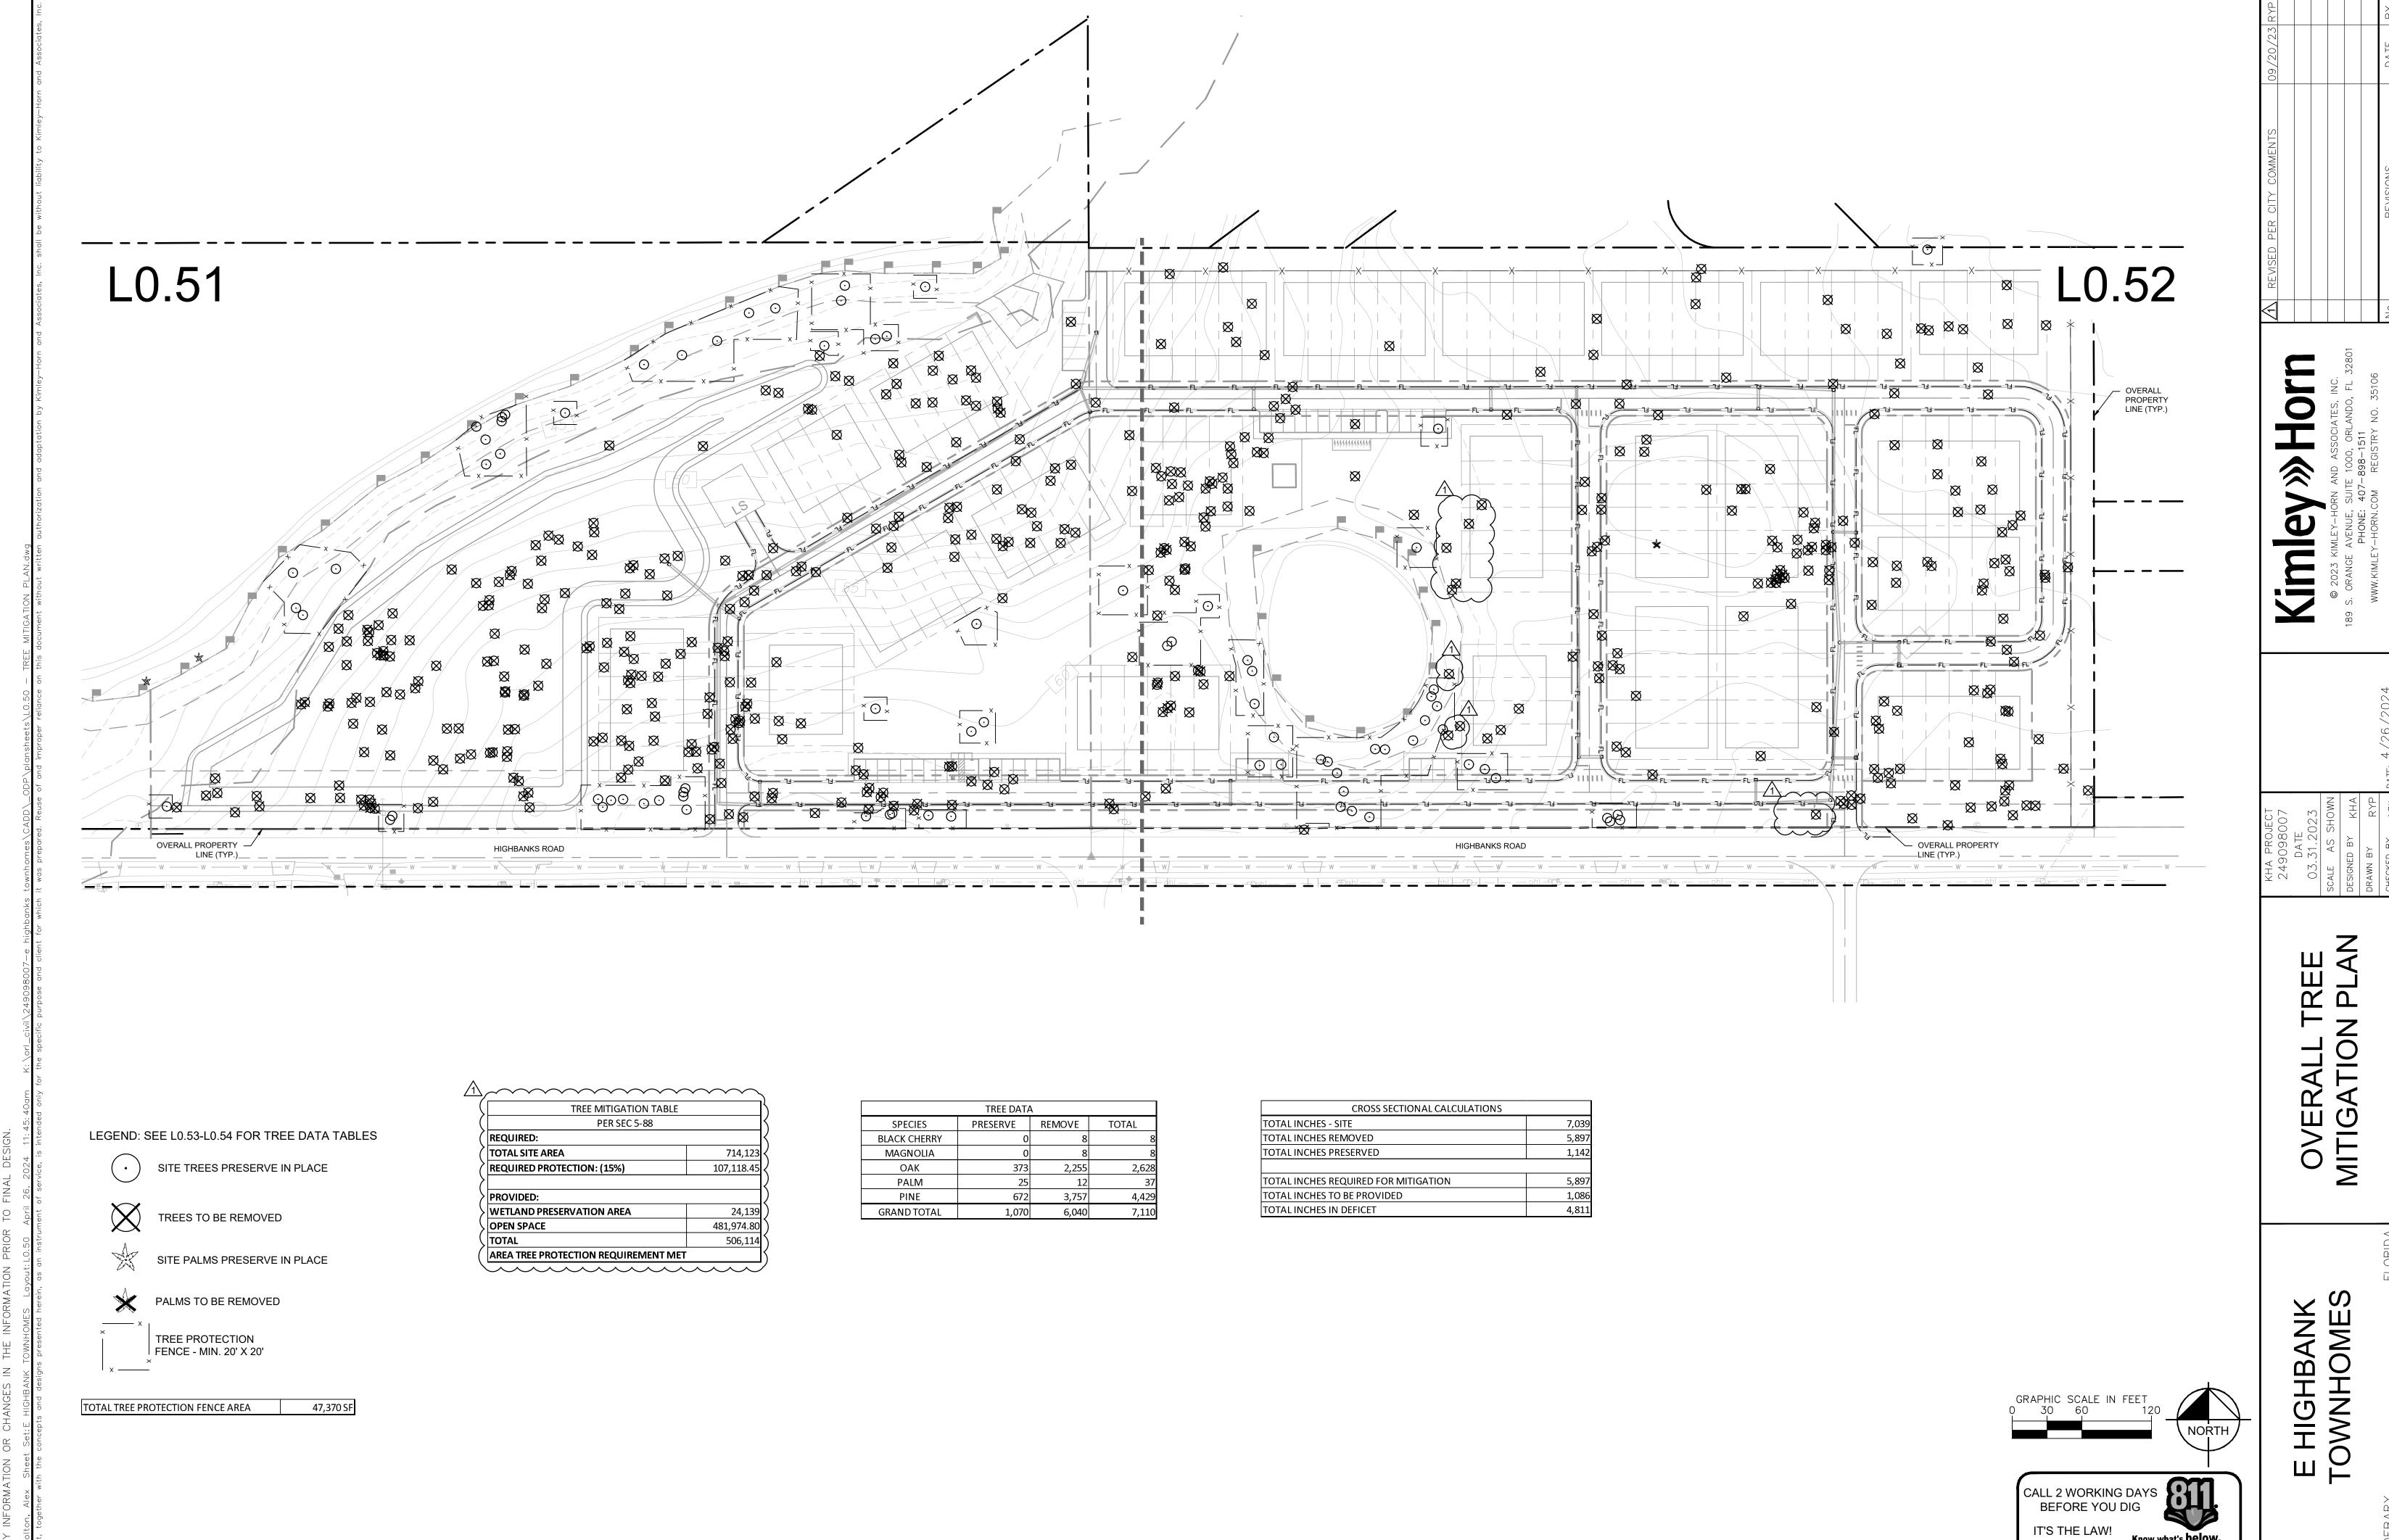

DIAL 811 Call before you dig SUNSHINE STATE ONE CALL OF FLORIDA, INC.

SHEET NUMBER L0.50

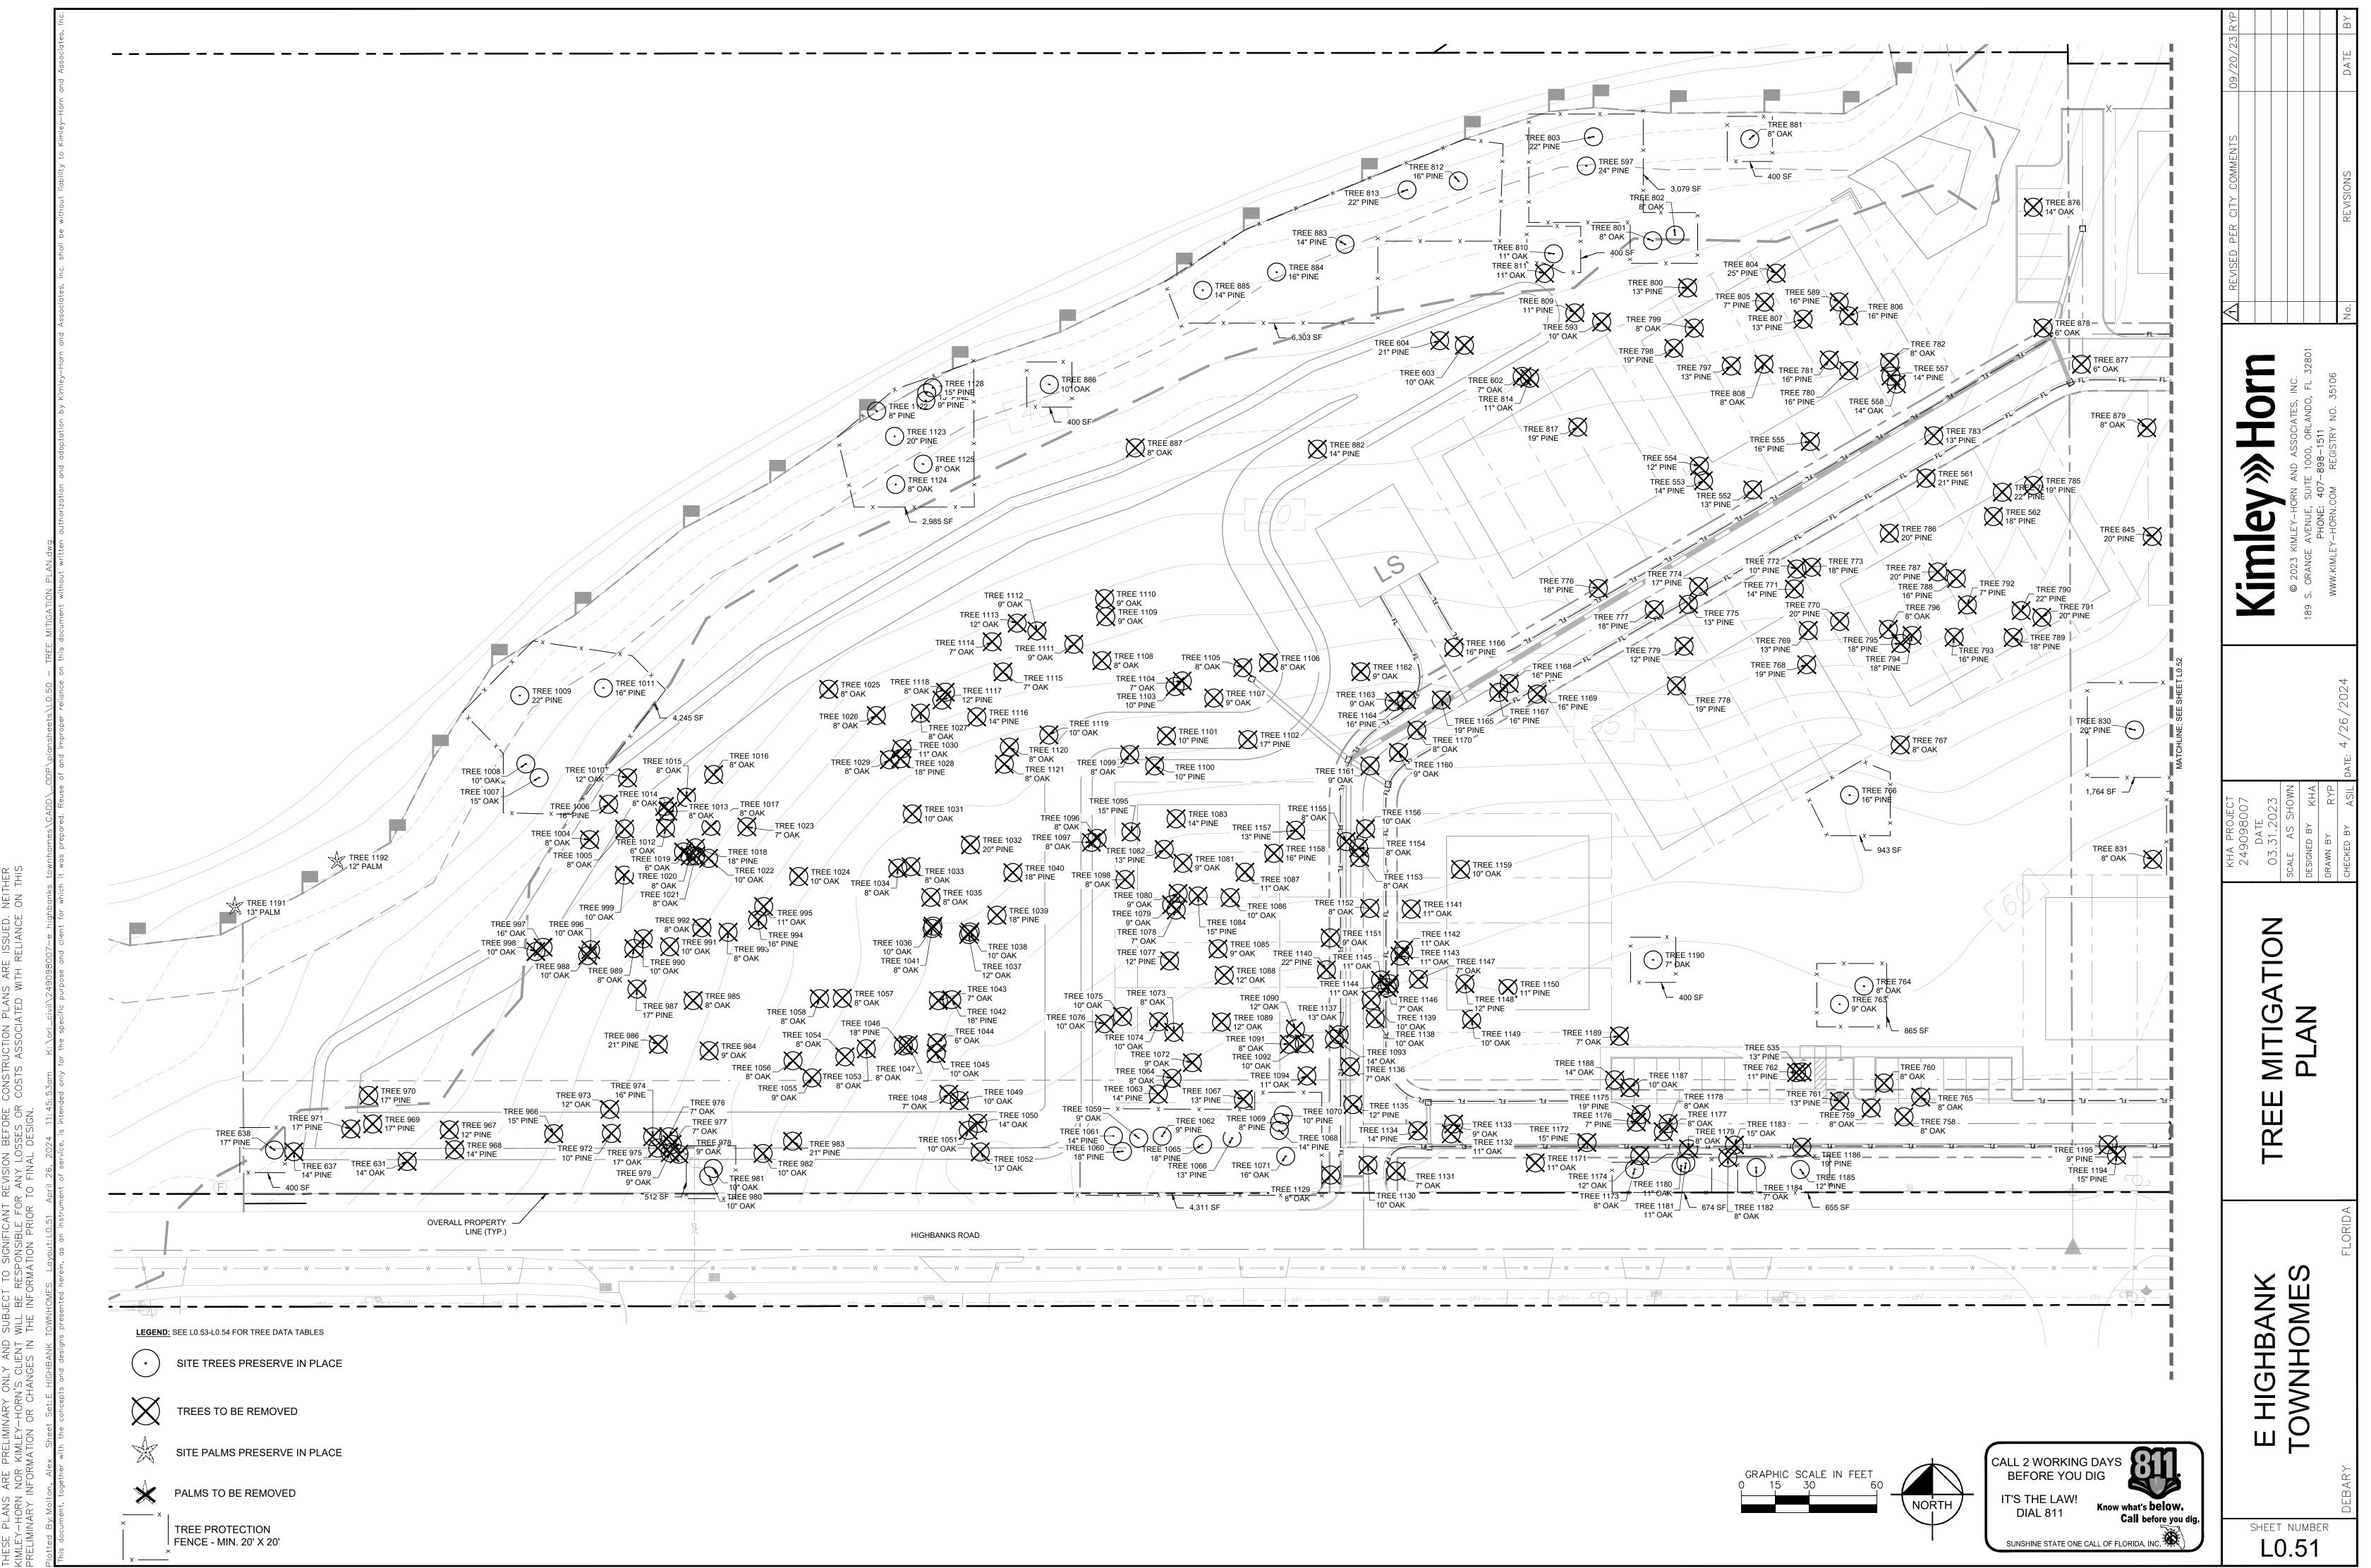

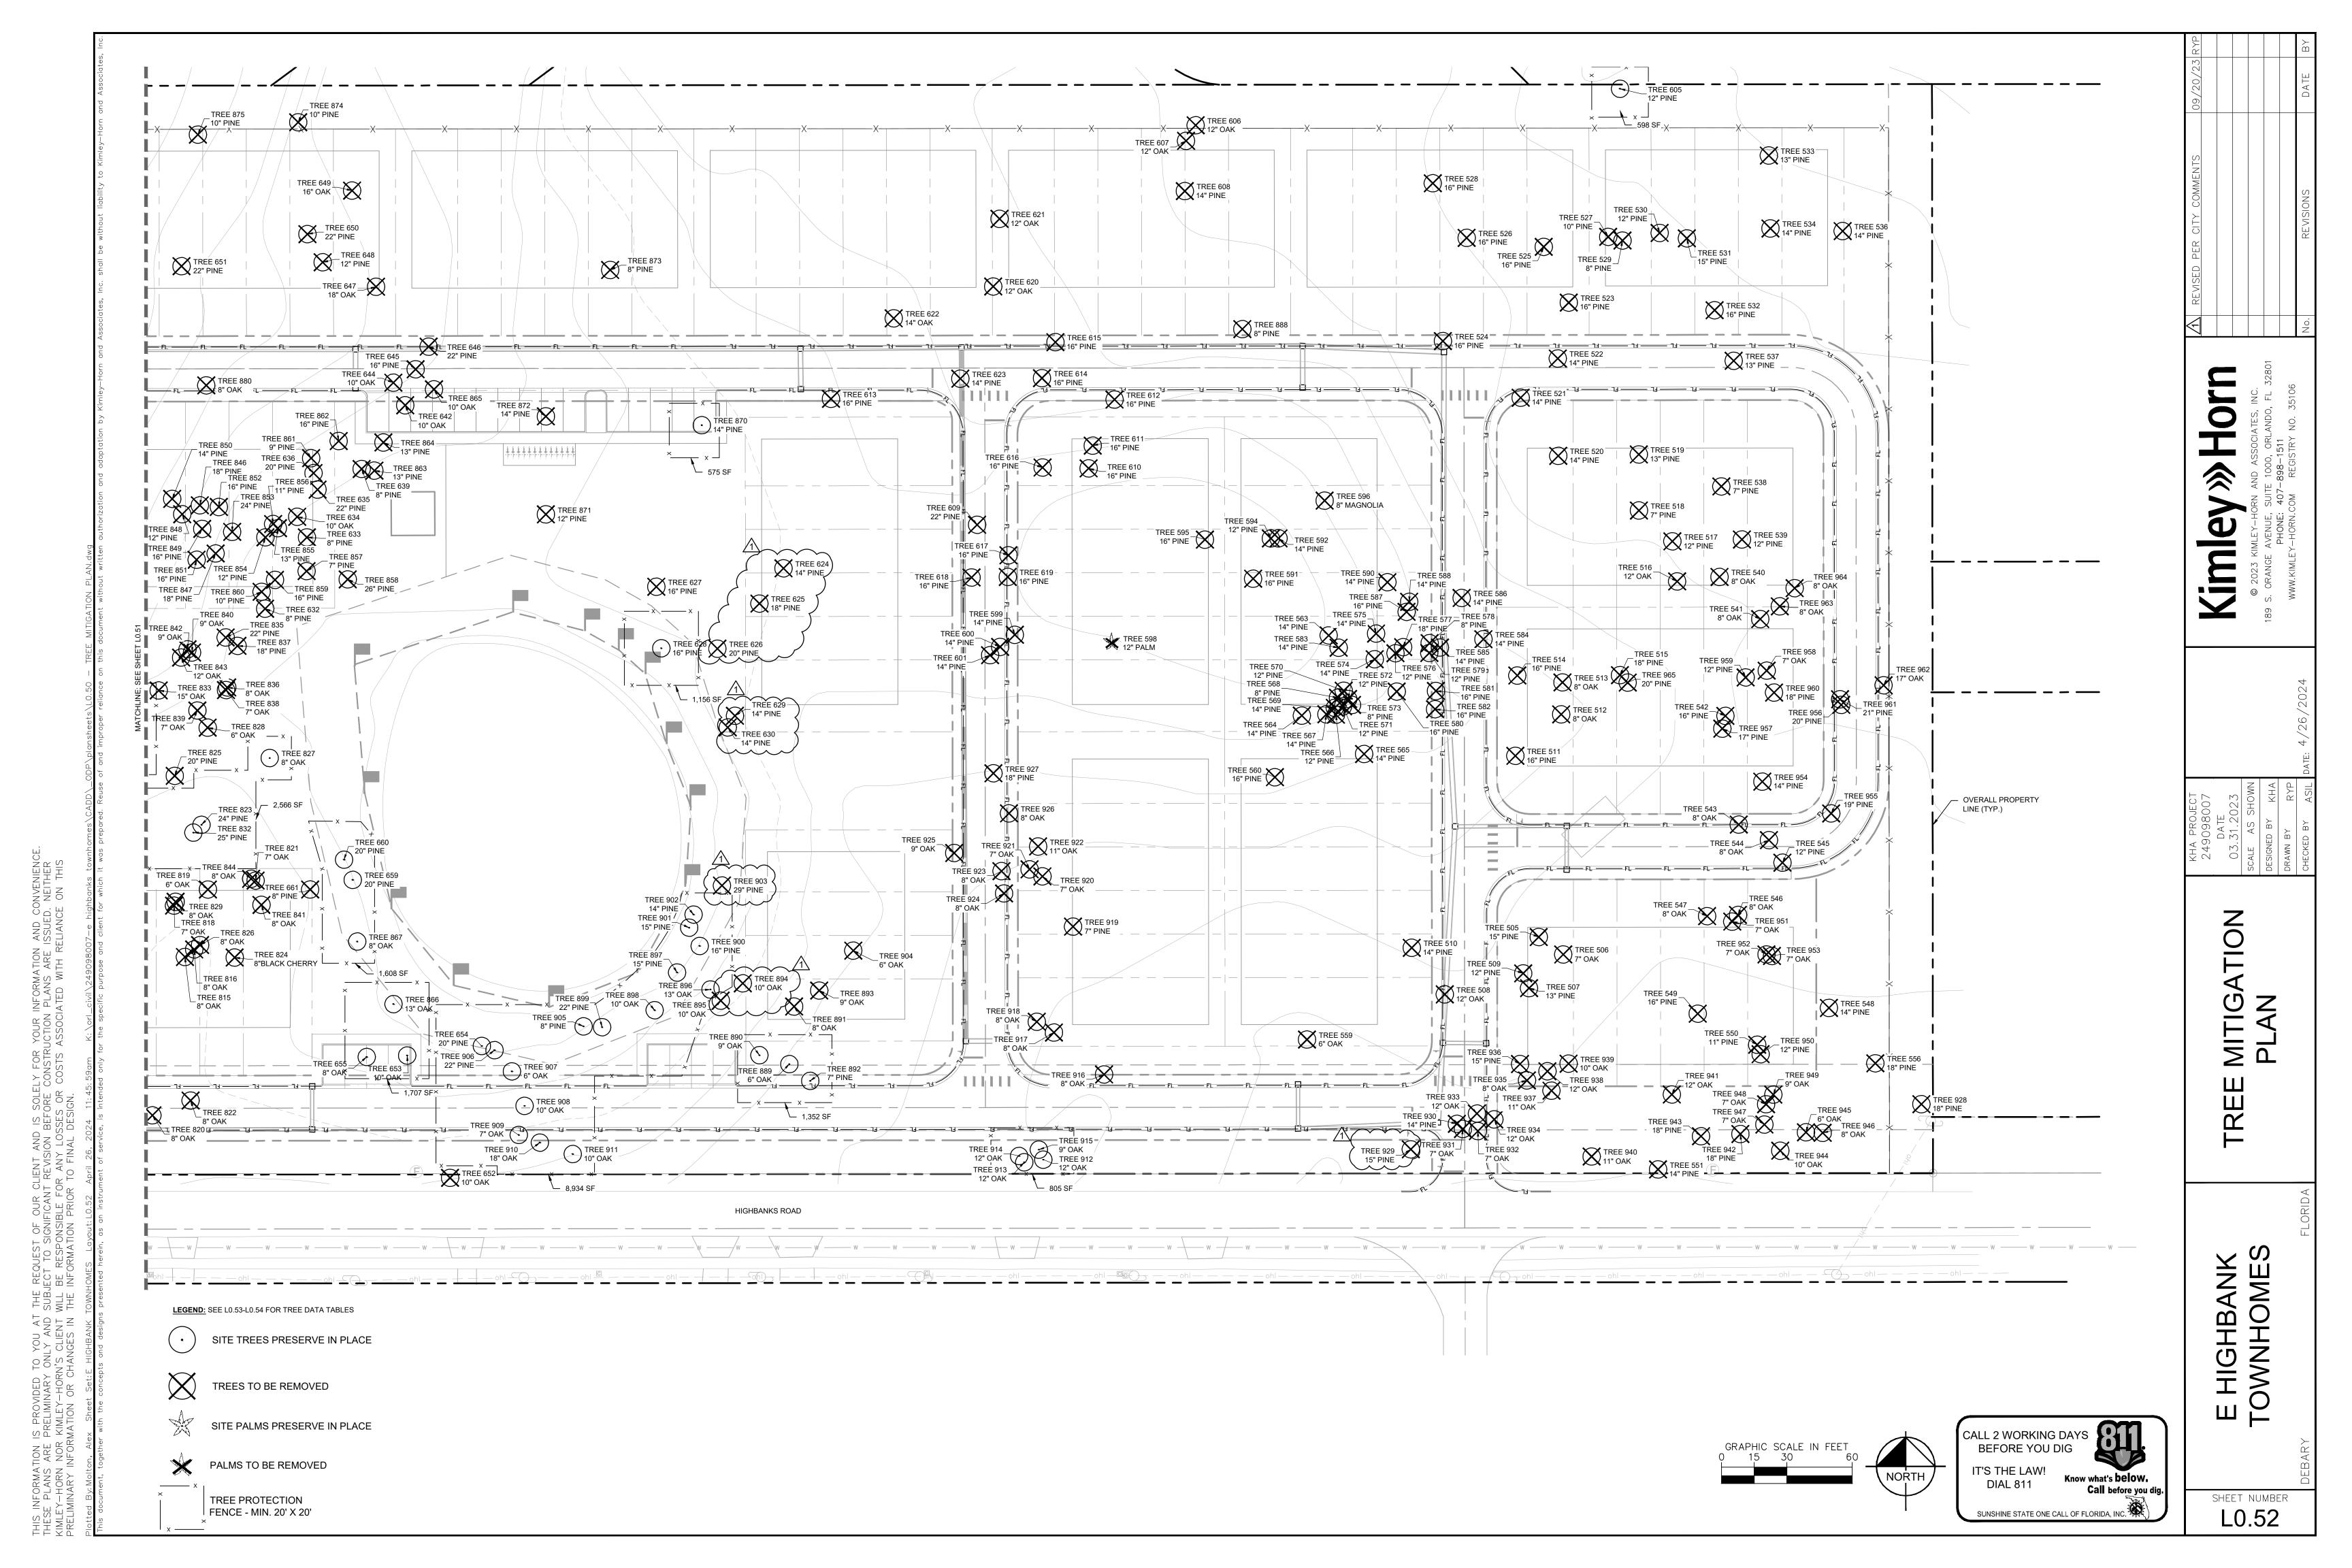

512 OAK 8" REMOVE 513 OAK 8" REMOVE 514 PINE 16" REMOVE 515 PINE 18" REMOVE 516 OAK 12" REMOVE 517 PINE 12" REMOVE 518 PINE 7" REMOVE 519 PINE 13" REMOVE 520 PINE 14" REMOVE 521 PINE REMOVE 522 PINE 14" REMOVE 523 PINE 16" REMOVE 524 PINE 16" REMOVE 525 PINE 16" REMOVE 526 PINE 16" REMOVE 527 PINE 10" REMOVE 528 PINE 16" REMOVE 529 PINE 8" REMOVE 530 PINE 12" REMOVE 531 PINE 15" REMOVE 532 PINE 16" REMOVE 533 PINE 13" REMOVE 534 PINE 14" REMOVE 535 PINE 13" REMOVE 536 PINE 14" REMOVE 537 PINE 13" REMOVE 538 PINE 7" REMOVE 539 PINE 12" REMOVE 540 OAK REMOVE 541 REMOVE 542 PINE 16" REMOVE 543 OAK 8" REMOVE 544 OAK 8" REMOVE 545 PINE 12" REMOVE 546 OAK 8" REMOVE 547 OAK 8" REMOVE 548 PINE 14" REMOVE 549 PINE 16" REMOVE 550 PINE 11" REMOVE 551 PINE 14" REMOVE 552 PINE 13" REMOVE 553 PINE 14" REMOVE 554 PINE 12" REMOVE 555 16" REMOVE 556 18" REMOVE 557 PINE REMOVE 14" 14" REMOVE 558 OAK 559 REMOVE 16" 560 PINE REMOVE 561 REMOVE 562 PINE 18" REMOVE 563 PINE REMOVE 564 PINE 14" REMOVE 565 PINE REMOVE 566 PINE 12" REMOVE 567 PINE 14" REMOVE 8" 568 PINE REMOVE REMOVE 569 PINE 14" 12" 570 PINE REMOVE 571 PINE 12" REMOVE 12" 572 PINE REMOVE REMOVE 573 PINE 574 PINE 14" REMOVE 575 PINE 14" REMOVE 12" 576 PINE REMOVE 577 PINE 18" REMOVE 578 PINE 8" REMOVE 579 PINE REMOVE 16" 580 PINE REMOVE 581 PINE REMOVE 16" 582 PINE REMOVE 583 PINE 14" REMOVE 14" 584 PINE REMOVE 585 PINE 14" REMOVE 586 PINE 14" REMOVE 587 PINE 16" REMOVE 588 PINE 14" REMOVE 589 PINE 16" REMOVE 590 PINE 14" REMOVE 591 PINE 16" REMOVE 592 PINE 14" REMOVE 593 OAK 10" REMOVE 594 PINE 12" REMOVE 595 PINE 16" REMOVE 596 MAGNOLIA 8" REMOVE 597 PINE 24" PRESERVE 598 PALM 12" REMOVE 599 PINE 14" REMOVE 14" 600 PINE REMOVE 601 PINE 14" REMOVE 602 OAK REMOVE 603 OAK 10" REMOVE

21" REMOVE

604

PINE

TREE NUMBER | SPECIES | DBH (INCHES) | ACTION | DESCRIPTION |

OAK

PINE

OAK

PINE

PINE

PINE

15" REMOVE 7" REMOVE

13" REMOVE

12" REMOVE

12" REMOVE 14" REMOVE

16" REMOVE

505

506

507

508

509

510

511

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IS PROVIDED

: PRELIMINARY

R KIMLEY-HORN

RMATION OR CF

TREE NUMBER	SPECIES	DBH (INCHES)	ACTION PRESERVE	DESCRIPTION
605 606	PINE OAK	12"	REMOVE	
607	OAK	12"	REMOVE	
608 609	PINE	14" 22"	REMOVE	
610	PINE PINE	16"	REMOVE REMOVE	
611	PINE	16"	REMOVE	
612 613	PINE	16" 16"	REMOVE REMOVE	
614	PINE	16"	REMOVE	
615	PINE	16"	REMOVE	
616 617	PINE	16" 16"	REMOVE REMOVE	
618	PINE	16"	REMOVE	
619	PINE	16"	REMOVE	
620 621	OAK OAK	12" 12"	REMOVE REMOVE	
622	OAK	14"	REMOVE	
623	PINE	14"	REMOVE	
624	PINE PINE	18"	ŶŔĔMOŶĔ\ REMOVE ⟨	
626	PINE	20"	REMOVE	
627	PINE	16"	REMOVE	
628	PINE	16"	PRESERVE RÉMOVE	
630	PINE	14"	REMOVE)	
631	OAK	14"	REMOVE	
632 633	PINE PINE	8" 8"	REMOVE REMOVE	
634	OAK	10"	REMOVE	
635	PINE	22"	REMOVE	
636 637	PINE PINE	20" 14"	REMOVE REMOVE	
638	PINE	17"	PRESERVE	
639	PINE	8"	REMOVE	
642 644	OAK OAK	10" 10"	REMOVE REMOVE	
645	PINE	16"	REMOVE	
646	PINE	22" 18"	REMOVE	CDECIMAENI
647 648	OAK PINE	12"	REMOVE REMOVE	SPECIMEN
649	OAK	16"	REMOVE	
650 651	PINE PINE	22"	REMOVE REMOVE	
652	OAK	10"	REMOVE	
653	OAK	10"	PRESERVE	
654 655	PINE OAK	20" 8"	PRESERVE PRESERVE	
659	PINE	20"	PRESERVE	
660	PINE	20"	PRESERVE	
758	PINE OAK	8" 8"	REMOVE REMOVE	
759	OAK	8"	REMOVE	
760	OAK	8"	REMOVE	
761 762	PINE PINE	13" 11"	REMOVE REMOVE	
763	OAK	9"	PRESERVE	
764	OAK	8"	PRESERVE	
765 766	OAK PINE	8" 16"	REMOVE PRESERVE	
767	OAK	8"	REMOVE	
768	PINE	19"	REMOVE	
769 770	PINE PINE	13" 20"	REMOVE REMOVE	
771	PINE	14"	REMOVE	
772	PINE	10"	REMOVE	
773 774	PINE PINE	18" 17"	REMOVE REMOVE	
775	PINE	13"	REMOVE	
776	PINE	18"	REMOVE	
777 778	PINE PINE	18" 19"	REMOVE REMOVE	
779	PINE	12"	REMOVE	
780	PINE	16"	REMOVE	
781 782	PINE OAK	16" 8"	REMOVE REMOVE	
783	PINE	13"	REMOVE	
784	PINE	22"	REMOVE	
785 786	PINE PINE	19" 20"	REMOVE REMOVE	
787	PINE	20"	REMOVE	
788	PINE	16"	REMOVE	
789 790	PINE PINE	18" 22"	REMOVE REMOVE	
791	PINE	20"	REMOVE	
792	PINE	7"	REMOVE	
793 794	PINE PINE	16" 18"	REMOVE REMOVE	
795	PINE	18"	REMOVE	
796	OAK	8"	REMOVE	
797 798	PINE PINE	13" 19"	REMOVE REMOVE	
798 799	OAK	8"	REMOVE	
800	PINE	13"	REMOVE	
801 802	OAK OAK	8" 8"	PRESERVE PRESERVE	
802	PINE	22"	PRESERVE	
804	PINE	25"	REMOVE	
805	PINE	7"	REMOVE	

806

PINE

16"

REMOVE

TREE NUMBER	SPECIES	DBH (INCHES)	ACTION	DESCRIPTION
807	PINE	13"	REMOVE	
808 809	OAK PINE	8" 11"	REMOVE REMOVE	
810	OAK	11"	PRESERVE	
811	OAK	11"	REMOVE	
812	PINE	16"	PRESERVE	
813	PINE	22"	PRESERVE	
814	OAK	11"	REMOVE	
815	OAK	8"	REMOVE	
816	OAK	8" 19"	REMOVE	
817 818	PINE OAK	7"	REMOVE REMOVE	
819	OAK	6"	REMOVE	
820	OAK	8"	REMOVE	
821	OAK	7"	REMOVE	
822	OAK	8"	REMOVE	
823	PINE	24"	PRESERVE	
824	BLACK CHERRY	8"	REMOVE	
825 826	PINE OAK	20" 8"	REMOVE REMOVE	
827	OAK	8"	PRESERVE	
828	OAK	6"	REMOVE	
829	OAK	8"	REMOVE	
830	PINE	20"	PRESERVE	
831	OAK	8"	REMOVE	
832	PINE	25"	PRESERVE	
833	OAK	15"	REMOVE	
835	PINE	22" 8"	REMOVE	
836 837	OAK PINE	8" 18"	REMOVE REMOVE	
838	OAK	7"	REMOVE	
839	OAK	7"	REMOVE	
840	OAK	9"	REMOVE	
841	OAK	8"	REMOVE	
842	OAK	9"	REMOVE	
843	OAK	12"	REMOVE	
844 845	OAK	8" 20"	REMOVE	
846	PINE PINE	18"	REMOVE REMOVE	
847	PINE	18"	REMOVE	
848	PINE	12"	REMOVE	
849	PINE	16"	REMOVE	
850	PINE	14"	REMOVE	
851	PINE	16"	REMOVE	
852	PINE	16"	REMOVE	
853 854	PINE PINE	24" 12"	REMOVE REMOVE	
855	PINE	13"	REMOVE	
856	PINE	11"	REMOVE	
857	PINE	7"	REMOVE	
858	PINE	26"	REMOVE	
859	PINE	16"	REMOVE	
860	PINE	10"	REMOVE	
861	PINE	9"	REMOVE	
862 863	PINE PINE	16" 13"	REMOVE REMOVE	
864	PINE	13"	REMOVE	
865	OAK	10"	REMOVE	
866	OAK	13"	PRESERVE	
867	OAK	8"	PRESERVE	
870	PINE	14"	PRESERVE	
871	PINE	12"	REMOVE	
872 873	PINE PINE	14" 8"	REMOVE REMOVE	
873 874	PINE	10"	REMOVE	
875	PINE	10"	REMOVE	
876	OAK	14"	REMOVE	
877	OAK	6"	REMOVE	
878	OAK	6"	REMOVE	
879 880	OAK	8" 8"	REMOVE	
880 881	OAK OAK	8" 8"	REMOVE PRESERVE	
882	PINE	14"	REMOVE	
883	PINE	14"	PRESERVE	
884	PINE	16"	PRESERVE	
885	PINE	14"	PRESERVE	
886	OAK	10"	PRESERVE	
887 888	OAK PINE	8" 8"	REMOVE	
889	OAK	8" 6"	REMOVE PRESERVE	
890	OAK	9"	PRESERVE	
891	OAK	8"	REMOVE	
892	PINE	7"	PRESERVE	
<u>1</u> 893	OAK	9"	REMOVE	
894	OAK	10"	RĚMÔVE	
895	OAK	10"	REMOVE	
896 897	OAK	13" 15"	PRESERVE PRESERVE	
897 898	PINE OAK	10"	PRESERVE	
899	PINE	22"	PRESERVE	
900	PINE	16"	PRESERVE	
901	PINE	15"	PRESERVE	
1 902	PINE	14"	PRESERVE	
903	PINE	29"	REMOVE REMOVE)
904	PINE	6" 8"	PRESERVE	
906	PINE	22"	PRESERVE	
907	OAK	6"	PRESERVE	

PRESERVE

PRESERVE

1011

1012

1013

PINE

OAK

OAK

16" PRESERVE

8"

REMOVE

REMOVE

10"

908

909

OAK

OAK

910	SPECIES OAK	DBH (INCHE:	S) ACTION PRESERVE	DESCRIPTIO SPECIMEN
911	OAK	10"	PRESERVE	
912	OAK	12"	PRESERVE	
913	OAK	12"	PRESERVE	
914 915	OAK OAK	12" 9"	PRESERVE PRESERVE	
915	OAK	8"	REMOVE	
917	OAK	8"	REMOVE	
918	OAK	8"	REMOVE	
919	PINE	7"	REMOVE	
920	OAK	7"	REMOVE	
921 922	OAK OAK	7" 11"	REMOVE REMOVE	
923	OAK	8"	REMOVE	
924	OAK	8"	REMOVE	
925	OAK	9"	REMOVE	
926	OAK	8"	REMOVE	
927	PINE	18"	REMOVE	
928	PINE	18"	REMOVE REMOVE	1
930	PINE	14"	REMOVE	/
931	OAK	7"	REMOVE	
932	OAK	7"	REMOVE	
933	OAK	12"	REMOVE	
934	OAK	12"	REMOVE	
935 936	OAK PINE	8" 15"	REMOVE REMOVE	
937	OAK	11"	REMOVE	
938	OAK	12"	REMOVE	
939	OAK	10"	REMOVE	
940	OAK	11"	REMOVE	
941 942	OAK PINE	12" 18"	REMOVE REMOVE	
942 943	PINE	18"	REMOVE	
944	OAK	10"	REMOVE	
945	OAK	6"	REMOVE	
946	OAK	8"	REMOVE	
947	OAK	7"	REMOVE	
948	OAK	7" 9"	REMOVE	
949 950	OAK PINE	12"	REMOVE REMOVE	
951	OAK	7"	REMOVE	
952	OAK	7"	REMOVE	
953	OAK	7"	REMOVE	
954	PINE	14"	REMOVE	
955 956	PINE PINE	19" 20"	REMOVE REMOVE	
957	PINE	17"	REMOVE	
958	OAK	7"	REMOVE	
959	PINE	12"	REMOVE	
960	PINE	18"	REMOVE	
961	PINE	21" 17"	REMOVE	
962 963	OAK OAK	8"	REMOVE REMOVE	
964	OAK	8"	REMOVE	
965	PINE	20"	REMOVE	
966	PINE	15"	REMOVE	
967	PINE	12"	REMOVE	
968 969	PINE PINE	14" 17"	REMOVE REMOVE	
970	PINE	17"	REMOVE	
971	PINE	17"	REMOVE	
972	PINE	10"	REMOVE	
973	OAK	12"	REMOVE	
974	PINE	16"	REMOVE	
975 976	OAK OAK	17" 7"	REMOVE REMOVE	
977	OAK	7"	REMOVE	
978	OAK	9"	REMOVE	
979	OAK	9"	REMOVE	
980	OAK	10"	PRESERVE	
981 982	OAK OAK	10" 10"	PRESERVE REMOVE	
982 983	PINE	21"	REMOVE	
984	OAK	9"	REMOVE	
985	OAK	8"	REMOVE	
986	PINE	21"	REMOVE	
987	PINE	17"	REMOVE	
988 989	OAK OAK	10" 8"	REMOVE REMOVE	
990	OAK	10"	REMOVE	
991	OAK	10"	REMOVE	
992	OAK	8"	REMOVE	
993	OAK	8"	REMOVE	
994	PINE	16"	REMOVE	
995 996	OAK	11" 10"	REMOVE	
996 997	OAK OAK	16"	REMOVE REMOVE	
998	OAK	10"	REMOVE	
999	OAK	10"	REMOVE	
1004	OAK	8"	REMOVE	
1005	OAK	8"	REMOVE	
1006	PINE	16"	REMOVE	
1007 1008	OAK OAK	15" 10"	PRESERVE PRESERVE	
7000		22"	PRESERVE	
1009	PINE	//	1 1 1 1 1 1 1 1 1 1 1 1 1 1 1 1 1 1 1 1	
1009 1010	PINE OAK	12"	REMOVE	

REMO	VE
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REMO'	VE
REMO	VE
REMO	VE
REMO'	VE
REMO	VE

TREE

E HIGHBANK TOWNHOMES

L0.53

SHEET NUMBER

TREE NUMBER	SPECIES	DBH (INCHES)	ACTION	DESCRIPTION
1014 1015	OAK OAK	8" 8"	REMOVE REMOVE	
1016	OAK	8"	REMOVE	
1017	OAK	8"	REMOVE	
1018 1019	PINE OAK	18" 6"	REMOVE REMOVE	
1020	OAK	8"	REMOVE	
1021	OAK	8" 10"	REMOVE	
1022 1023	OAK OAK	7"	REMOVE REMOVE	
1024	OAK	10"	REMOVE	
1025 1026	OAK OAK	8" 8"	REMOVE REMOVE	
1026	OAK	8"	REMOVE	
1028	PINE	18"	REMOVE	
1029 1030	OAK OAK	8" 11"	REMOVE REMOVE	
1030	OAK	10"	REMOVE	
1032	PINE	20"	REMOVE	
1033 1034	OAK OAK	8" 8"	REMOVE REMOVE	
1035	OAK	8"	REMOVE	
1036	OAK	10"	REMOVE	
1037 1038	OAK OAK	12" 10"	REMOVE REMOVE	
1039	PINE	18"	REMOVE	
1040	PINE	18"	REMOVE	
1041 1042	OAK PINE	8" 18"	REMOVE REMOVE	
1043	OAK	7"	REMOVE	
1044	OAK	6"	REMOVE	
1045 1046	OAK PINE	10" 18"	REMOVE REMOVE	
1047	OAK	8"	REMOVE	
1048	OAK	7"	REMOVE	
1049 1050	OAK OAK	10"	REMOVE REMOVE	
1051	OAK	10"	REMOVE	
1052	OAK	13"	REMOVE	
1053 1054	OAK OAK	8" 8"	REMOVE REMOVE	
1055	OAK	9"	REMOVE	
1056	OAK	8"	REMOVE	
1057 1058	OAK OAK	8" 8"	REMOVE REMOVE	
1059	OAK	9"	PRESERVE	
1060	PINE	18"	PRESERVE	
1061 1062	PINE PINE	9"	PRESERVE PRESERVE	
1063	PINE	14"	REMOVE	
1064	OAK	8"	REMOVE	
1065 1066	PINE PINE	18" 13"	PRESERVE PRESERVE	
1067	PINE	13"	REMOVE	
1068	PINE	14"	PRESERVE	
1069 1070	PINE PINE	8" 10"	PRESERVE PRESERVE	
1071	OAK	16"	PRESERVE	
1072	OAK	9" 8"	REMOVE	
1073 1074	OAK OAK	10"	REMOVE REMOVE	
1075	OAK	10"	REMOVE	
1076 1077	OAK PINE	10" 12"	REMOVE REMOVE	
1077	OAK	7"	REMOVE	
1079	OAK	9"	REMOVE	
1080 1081	OAK OAK	9" 9"	REMOVE REMOVE	
1081	PINE	13"	REMOVE	
1083	PINE	14"	REMOVE	
1084 1085	PINE OAK	15" 9"	REMOVE REMOVE	
1086	OAK	10"	REMOVE	
1087	OAK	11"	REMOVE	
1088 1089	OAK OAK	12" 12"	REMOVE REMOVE	
1090	OAK	12"	REMOVE	
1091	OAK	8"	REMOVE	
1092 1093	OAK OAK	10" 14"	REMOVE REMOVE	
1094	OAK	11"	REMOVE	
1095	PINE	15"	REMOVE	
1096 1097	OAK OAK	8" 8"	REMOVE REMOVE	
1097	OAK	8"	REMOVE	
1099	OAK	8"	REMOVE	
1100 1101	PINE PINE	10"	REMOVE REMOVE	
1101	PINE	17"	REMOVE	
1103	PINE	10"	REMOVE	
1104 1105	OAK OAK	7" 8"	REMOVE REMOVE	
1105	OAK	8"	REMOVE	
1107	OAK	9"	REMOVE	
1108	OAK OAK	8" 9"	REMOVE REMOVE	
1100	CIAK	ı y	LEIVIOVE	ĺ
1109 1110	OAK	9"	REMOVE	
		9" 9" 9"	REMOVE REMOVE REMOVE	

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RELIMINARY INFORMATION OR CHANGES IN THE INFORMATION PRIOR TO FINAL DESIGN.

TREE NUMBER	SPECIES	DBH (INCHES)	ACTION	DESCRIPTION
1114	OAK	7"	REMOVE	
1115 1116	OAK PINE	7"	REMOVE	
1117	PINE	12"	REMOVE REMOVE	
1118	OAK	8"	REMOVE	
1119	OAK	10"	REMOVE	
1120	OAK	8"	REMOVE	
1121	OAK	8"	REMOVE	
1122	PINE	8"	PRESERVE	
1123	PINE	20"	PRESERVE	
1124	OAK	8"	PRESERVE	
1125	OAK	8"	PRESERVE	
1126	PINE	9"	PRESERVE	
1127	PINE	15" 15"	PRESERVE	
1128 1129	PINE OAK	8"	PRESERVE REMOVE	
1130	OAK	10"	REMOVE	
1131	OAK	7"	REMOVE	
1132	OAK	11"	REMOVE	
1133	OAK	9"	REMOVE	
1134	PINE	14"	REMOVE	
1135	PINE	12"	REMOVE	
1136	OAK	7"	REMOVE	
1137	OAK	13"	REMOVE	
1138	OAK	10"	REMOVE	
1139	OAK	10"	REMOVE	
1140	PINE	22"	REMOVE	
1141 1142	OAK OAK	11"	REMOVE REMOVE	
1142	OAK	11"	REMOVE	
1144	OAK	11"	REMOVE	
1145	OAK	11"	REMOVE	
1146	OAK	7"	REMOVE	
1147	OAK	7"	REMOVE	
1148	PINE	12"	REMOVE	
1149	OAK	10"	REMOVE	
1150	PINE	11"	REMOVE	
1151	OAK	9"	REMOVE	
1152	OAK	8"	REMOVE	
1153	OAK	8"	REMOVE	
1154 1155	OAK OAK	8" 8"	REMOVE REMOVE	
1156	OAK	10"	REMOVE	
1157	PINE	13"	REMOVE	
1158	PINE	16"	REMOVE	
1159	OAK	10"	REMOVE	
1160	OAK	9"	REMOVE	
1161	OAK	9"	REMOVE	
1162	OAK	9"	REMOVE	
1163	OAK	9"	REMOVE	
1164	PINE	16"	REMOVE	
1165	PINE	19"	REMOVE	
1166	PINE	16"	REMOVE	
1167	PINE	16"	REMOVE	
1168	PINE PINE	16" 16"	REMOVE REMOVE	
1169 1170	OAK	8"	REMOVE	
1171	OAK	11"	REMOVE	
1172	PINE	15"	REMOVE	
1173	OAK	8"	PRESERVE	
1174	OAK	12"	REMOVE	
1175	PINE	19"	REMOVE	
1176	PINE	7"	REMOVE	
1177	OAK	8"	REMOVE	
1178	OAK	8"	REMOVE	
1179	OAK	8"	REMOVE	
1180	OAK	11"	PRESERVE	
1181	OAK	11"	PRESERVE	
1182	OAK	8" 15"	REMOVE	
1183 1184	OAK OAK	7"	REMOVE PRESERVE	
1184	PINE	12"	PRESERVE	
1186	PINE	19"	REMOVE	
1187	OAK	10"	REMOVE	
1188	OAK	14"	REMOVE	
1189	OAK	7"	REMOVE	
1190	OAK	7"	PRESERVE	
1191	PALM	13"	PRESERVE	
1192	PALM	12"	PRESERVE	
1194	PINE	15"	REMOVE	
1195	PINE	9"	REMOVE	

TREE MITIGATION TABL	<u>.E</u>
PER SEC 5-88	
REQUIRED:	
TOTAL SITE AREA	714,123
REQUIRED PROTECTION: (15%)	107,118.4
PROVIDED:	
WETLAND PRESERVATION AREA	24,139
OPEN SPACE	481,974.80
TOTAL	506,114
AREA TREE PROTECTION REQUIREMENT N	ACT

TOTAL TREE PROTECTION FENCE AREA	47,370 SF

	TREE DATA	1	
SPECIES	PRESERVE	REMOVE	TOTAL
BLACK CHERRY	0	8	8
MAGNOLIA	0	8	8
OAK	373	2,255	2,628
PALM	25	12	37
PINE	672	3,757	4,429
GRAND TOTAL	1,070	6,040	7,110

TOTAL INCHES - SITE	7,0
TOTAL INCHES REMOVED	5,8
TOTAL INCHES PRESERVED	1,1
TOTAL INCHES REQUIRED FOR MITIGATION	5,89
TOTAL INCHES TO BE PROVIDED	1,0
TOTAL INCHES IN DEFICET	4,8

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	No.	REVISIONS	DATE

REVISED PER CITY COMMENTS						REVISIONS
\triangleleft						No.
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E HIGHBANK TOWNHOMES

DATA

TREE

SHEET NUMBER

A. GENERAL

- CONTRACTOR SHALL ADHERE TO ALL TREE PROTECTION REQUIREMENTS LISTED IN THESE SPECIFICATIONS AND/OR THOSE LISTED IN THE CITY OR COUNTY ZONING CODE, TREE PROTECTION (LATEST EDITION). WHICHEVER IS MORE STRINGENT SHALL APPLY.
- 2. CONTRACTOR SHALL COORDINATE ALL CONSTRUCTION PROCEDURES WITH THE PROJECT ARBORIST PRIOR TO BEGINNING WORK.
- 3. ANY AREAS SUBJECT TO EROSION MUST BE ADEQUATELY STABILIZED WITH VEGETATION MATERIAL THAT WILL, WITHIN A REASONABLE TIME FRAME, DETER SOIL DISTURBANCE.
- 4. NO SIGNS, BUILDING PERMITS, WIRES OR OTHER ATTACHMENTS OF ANY KIND SHALL BE ATTACHED TO ANY TREE OR PALM. GUY WIRES DESIGNED TO PROTECT TREES ARE EXCLUDED FROM THIS PROHIBITION.
- 5. EXISTING TREE LOCATIONS AND SIZES ARE ESTIMATES AND ARE BASED ON A SURVEY PROVIDED BY THE OWNER SELECTED SURVEYOR.
- 6. CONTRACTOR SHALL COORDINATE TREE REMOVAL WITH PERMITTING AGENCY AND PROJECT ARBORIST PRIOR TO CONSTRUCTION. NO PERSON MAY REMOVE OR CAUSE TO BE REMOVED ANY PROTECTED TREE OR PALM WITHOUT FIRST HAVING PROCURED A PERMIT AS PROVIDED BY THE APPROPRIATE PERMITTING AGENCY.
- 7. FOR PROTECTED TREES OR PALMS BEING REMOVED, THE CONTRACTOR MUST GIVE THE PERMITTING AGENCY REASONABLE OPPORTUNITY TO RELOCATE TREES DESIGNATED FOR REMOVAL TO ANOTHER SITE AT THE PERMITTING AGENCY'S EXPENSE.
- CONTRACTOR IS RESPONSIBLE FOR POSSESSING ALL REQUIRED APPLICATOR LICENSES, BUSINESS REGISTRATIONS AND INSURANCE, PESTICIDE LABELS, AND MATERIAL DATA SAFETY SHEETS. THE CONTRACTOR IS ALSO RESPONSIBLE FOR HAVING ALL SPILL CONTAINMENT MATERIALS AND REQUIRED PERSONAL PROTECTIVE EQUIPMENT FOR PESTICIDE APPLICATIONS AND ACCIDENTAL SPILLS ON SITE AT ALL TIMES. THE OWNER RESERVES THE RIGHT TO INSPECT EACH APPLICATOR AND HAVE THESE MATERIALS PRESENTED BEFORE AND DURING ANY PESTICIDE TREATMENT.
- 9. WHERE TRAFFIC AREAS ARE PROPOSED WITHIN THE DRIP LINE OF PROTECTED TREES AND LESS THAN FOUR (4) INCHES OF GRADE CHANGE ARE PROPOSED, PERMEABLE SURFACES THAT ALLOW AIR AND WATER INTO THE SOIL SHOULD BE USED IN LIEU OF ASPHALT OR OTHER SUCH IMPERVIOUS SURFACES.
- 10. TREE WELLS OF AN APPROVED DESIGN SHALL BE CONSTRUCTED AROUND ALL TREES TO BE PRESERVED WHEN MORE THAN FOUR INCHES OF FILL IS TO BE DEPOSITED WITHIN THE DRIP LINE AREA OF THOSE TREES. COORDINATE WITH PROJECT ARBORIST.
- 11. THE SEQUENCE OF TREE MITIGATION AND PRESERVATION MEASURES IS IMPERATIVE TO THE HEALTH AND SURVIVABILITY OF THE SUBJECT TREES AND SHALL BE COORDINATED WITH THE OWNER SELECTED PROJECT ARBORIST. THE DESIRED SEQUENCE IS OUTLINED BELOW:
- a. TREE PROTECTION FENCING.
- b. ROOT PRUNING AND ROOT BARRIERS.
- c. CLEARING.
- d. TREE CANOPY PRUNING.
- e. FERTILIZATION.
- f. INSECTICIDE.
- g. IRRIGATION.

B. TREE PROTECTION FENCING

- 1. PRIOR TO THE ERECTION OF ANY TREE PROTECTION FENCING, ALL FOREIGN SURFACE MATERIAL, TRASH OR DEBRIS SHALL BE REMOVED FROM THE AREA TO BE ENCLOSED BY THE FENCING. AFTER ERECTION OF THE FENCING NO SUCH MATERIAL OR LITTER SHALL BE PERMITTED TO REMAIN WITHIN THE PROTECTED AREA.
- 2. TREE PROTECTION FENCING SHALL BE PLACED AROUND ALL PROTECTED TREES TO CREATE A PROTECTIVE ROOT ZONE AND SHALL REMAIN IN PLACE UNTIL SITE CLEARING, LAND ALTERATION, AND CONSTRUCTION ACTIVITIES ARE COMPLETE.
- 3. NATIVE GROUND COVER AND UNDERSTORY VEGETATION EXISTING WITHIN THE PROTECTED AREA SHALL REMAIN THROUGHOUT CONSTRUCTION. OTHER DESIGNATED VEGETATION AND INVASIVE PLANT SPECIES SHALL BE REMOVED ONLY BY MANUAL LABOR UTILIZING HAND TOOLS, OR BY OTHER METHODS APPROVED BY THE PROJECT ARBORIST.
- 4. TREE PROTECTION FENCING TYPES AND LOCATIONS SHALL BE ERECTED AS SHOWN ON THE TREE MITIGATION PLANS AND DETAILS, OR AS REQUESTED BY LOCAL AGENCY.
- 5. FINAL LOCATIONS SHALL BE COORDINATED WITH AND APPROVED BY THE PROJECT ARBORIST.
- 6. NO MATERIALS, EQUIPMENT, SPOIL, WASTE OR WASHOUT WATER MAY BE DEPOSITED, STORED, OR PARKED WITHIN 20 FEET OF THE TREE PROTECTION ZONE.
- 7. EROSION CONTROL DEVICES SUCH AS SILT FENCING, DEBRIS BASINS, AND WATER DIVERSION STRUCTURES SHALL BE INSTALLED TO PREVENT SILTATION AND/OR EROSION WITHIN THE TREE PROTECTION ZONE.
- 8. CONSTRUCTION ACTIVITY SHALL NOT DESTROY OR IRREVERSIBLY HARM THE ROOT SYSTEM OF PROTECTED TREES. POST HOLES AND TRENCHES LOCATED CLOSE TO PROTECTED TREES SHALL BE ADJUSTED TO AVOID DAMAGE TO MAJOR ROOTS.
- 9. DO NOT INSTALL CONDUIT, DRAIN OR IRRIGATION LINES, OR ANY UTILITY LINE WITHIN THE TREE PROTECTION ZONE WITHOUT THE APPROVAL OF THE PROJECT ARBORIST. IF LINES MUST TRAVERSE THE PROTECTION AREA, THEY SHALL BE TUNNELED OR BORED UNDER THE TREE
- 10. CONTRACTOR'S ACCESS TO FENCED TREE PROTECTION AREAS WILL BE PERMITTED ONLY WITH APPROVAL OF THE PROJECT ARBORIST.
- 11. EXCAVATION OR GRADING REQUIRED WITHIN THE PROTECTED AREA SHALL BE LIMITED TO THREE (3) INCHES OF CUT OR FILL. COORDINATE WITH PROJECT ARBORIST.
- 12. STRUCTURES AND UNDERGROUND FEATURES TO BE REMOVED WITHIN THE TREE PROTECTION ZONE SHALL BE COORDINATED WITH THE PROJECT ARBORIST.
- 13. TREE PROTECTION FENCING AROUND TREES TO BE RELOCATED SHALL BE ERECTED UNTIL THE TREE IS READY TO BE RELOCATED AND NEW FENCING SHALL BE ERECTED AT THE TREES NEW LOCATION AND WILL REMAIN IN PLACE UNTIL ALL CONSTRUCTION
- 14. IF ANY DAMAGE TO TREE PROTECTION FENCING SHOULD OCCUR BY ACCIDENT OR NEGLIGENCE, THE CONTRACTOR SHALL BE
- RESPONSIBLE FOR IMMEDIATE REPAIRS.
- 15. IF TEMPORARY HAUL OR ACCESS ROADS MUST PASS OVER THE PROTECTED AREA OF TREES TO BE PRESERVED, A ROAD BED OF SIX (6) INCHES OF MULCH OR GRAVEL SHALL BE CREATED TO PROTECT THE SOIL. THE ROAD BED MATERIAL SHALL BE REPLENISHED AS NECESSARY TO MAINTAIN A SIX (6) INCH ROAD BED AT ALL TIMES. CONTRACTOR SHALL REMOVE ALL SUCH MATERIALS FROM THE SITE AS SOON AS TEMPORARY ACCESS IS NO LONGER NECESSARY.
- 16. CONTRACTOR SHALL COORDINATE WITH THE PROJECT ARBORIST PRIOR TO THE REMOVAL OF ALL TREE PROTECTION FENCING.
- C. ROOT PRUNING/TRENCHING
- TRENCHING LOCATIONS SHALL BE APPROVED IN THE FIELD BY THE PROJECT ARBORIST.
- TRENCHING EQUIPMENT THAT WILL TURN AT HIGH RPM'S IS PREFERRED, AND SHALL BE APPROVED BY THE PROJECT ARBORIST.
 APPROVED EQUIPMENT WILL BE USED TO PERFORM ALL ROOT PRUNING OPERATIONS. A MINIMUM DEPTH OF THREE FEET IS
 REQUIRED.
- 3. INSTALL ROOT BARRIER WHERE DESIGNATED. SEE TREE MITIGATION PLAN AND DETAIL SHEETS.
- 4. THE TRENCH SHALL BE BACKFILLED WITH PREVIOUSLY EXCAVATED SOIL AND COMPACTED IMMEDIATELY.
- 5. TREES TO BE RELOCATED SHALL BE ROOT PRUNED A MINIMUM OF TWELVE (12) WEEKS PRIOR TO TREE RELOCATION.
- 6. WHEN THE TREE ROOT ZONE WILL BE DISTURBED, AFFECTED ROOTS MUST BE SEVERED BY CLEAN PRUNING CUTS AT THE POINT WHERE CONSTRUCTION IMPACTS THE ROOTS.

D. CLEARIN

- 1. ANY BRUSH CLEARING REQUIRED WITHIN THE TREE PROTECTION ZONE SHALL BE ACCOMPLISHED WITH HAND-OPERATED EQUIPMENT.
- 2. CONTRACTOR SHALL CLEAR ALL TREE PROTECTION AREAS OF VINES, SHRUBS, GROUND COVERS, WEEDS, SAPLINGS, AND INVASIVES LISTED ON THE LATEST EDITION OF THE FLORIDA EXOTIC PEST PLANT COUNCIL'S LIST OF INVASIVE SPECIES.
- 3. PROJECT ARBORIST MUST APPROVE METHODS OTHER THAN HAND CLEARING.

4. A TWO (2) INCH LAYER OF MULCH SHALL BE APPLIED OVER THE SURFACE OF EXPOSED ROOTS OF PROTECTED TREES DURING THE SITE CLEARING PHASE.

TREE CANODY DRUNING

- TREE PRUNING SPECIFICATIONS SHALL BE DEFINED BASED ON SPECIFIC RECOMMENDATIONS OF THE PROJECT ARBORIST. INFORMATION PRESENTED BELOW SHOULD BE USED AS A GUIDELINE.
- 2. CONTRACTOR SHALL VISIT THE SITE WITH THE PROJECT ARBORIST TO VERIFY THE EXTENT OF REQUIRED PRUNING.
- 3. ALL PRUNING SHALL BE PERFORMED IN ACCORDANCE WITH THE RECOMMENDATIONS OF A QUALIFIED INTERNATIONAL SOCIETY OF ARBORICULTURE (ISA) CERTIFIED ARBORIST OR AN AMERICAN SOCIETY OF CONSULTING ARBORISTS (ASCA) REGISTERED CONSULTING ARBORIST (RCA).
- 4. AT LEAST ONE MEMBER OF THE PRUNING CREW SHALL BE AN ISA CERTIFIED ARBORIST.
- 5. WHILE IN THE TREE, THE ARBORIST SHALL PERFORM AN AERIAL INSPECTION TO IDENTIFY DEFECTS THAT REQUIRE TREATMENT. ANY ADDITIONAL WORK NEEDED SHALL BE REPORTED TO THE OWNER.
- 6. PRUNING CUTS SHALL BE DONE IN ACCORDANCE WITH THE LATEST EDITION OF THE ANSI A300 PRUNING STANDARD (AMERICAN NATIONAL STANDARD FOR TREE CARE OPERATIONS) AND WORK SHALL BE PERFORMED IN ACCORDANCE WITH THE LATEST EDITION OF ANSI Z133.1 SAFETY STANDARD. PRUNING SHALL BE IN ACCORDANCE WITH THE LATEST EDITION OF ISA'S "BEST MANAGEMENT PRACTICES: TREE PRUNING".
- 7. WHERE TEMPORARY CLEARANCE IS NEEDED FOR ACCESS, BRANCHES SHALL BE TIED BACK TO HOLD THEM OUT OF THE CLEARANCE ZONE.
- 8. NO MORE THAN 20 PERCENT OF LIVE FOLIAGE SHALL BE REMOVED WITHIN ANY TREE.
- 9. ALL TREES WITHIN THE PROJECT AREA SHALL BE PRUNED AS FOLLOWS:

DIAMETER OR AS DIRECTED BY THE PROJECT ARBORIST.

- a. LIVE BRANCH PRUNING SHOULD BE PERFORMED ONLY WHEN THE DANGER OF INSECT OR DISEASE INFESTATION IS NOT PRESENT.
- b. REMOVE STUBS, CUTTING OUTSIDE THE WOUND WOOD TISSUE THAT HAS FORMED AROUND THE BRANCH.
- c. CLEANING, FOR THE SELECTIVE REMOVAL OF DEAD, DISEASED, BROKEN, OR CROSSING BRANCHES DOWN TO ONE INCH IN
- d. PRUNING CUTS LARGER THAN 4 INCHES IN DIAMETER, EXCEPT FOR DEAD WOOD, SHALL BE AVOIDED.
- e. PRUNING CUTS THAT EXPOSE HEARTWOOD SHALL BE AVOIDED WHENEVER POSSIBLE.
- e. I NOMING COTO THAT EXPOSE HEARTWOOD SHALL BE AVOIDED WHENEVERT COSIDEE.
- f. ALL TREES WITH CROWNS THAT PROJECT INTO PARKING LOT/ROADWAY AREAS SHALL BE RAISED TO 14 FEET ABOVE FINISHED GRADE.
- g. ALL TREES WITH CROWNS THAT PROJECT INTO SIDEWALK AREAS SHALL BE RAISED TO A HEIGHT OF 8 FEET ABOVE FINISHED GRADE.
- P. TREES, WHO'S ROOT SYSTEMS WILL BE IMPACTED SHALL RECEIVE THE FOLLOWING PRUNING TO COMPENSATE FOR ROOT LOSS:
- a. THE LOCATION AND SIZE OF BRANCHES FOR REDUCTION SHALL BE DEFINED BY THE PROJECT ARBORIST.
- b. REDUCTION, OR THE SELECTIVE PRUNING TO REDUCE TREE HEIGHT OR SPREAD.
- c. REDUCE END WEIGHT ON HEAVY, HORIZONTAL BRANCHES BY SELECTIVELY REMOVING SMALL DIAMETER BRANCHES, NO GREATER THAN 2 TO 3 INCHES, NEAR THE ENDS OF SCAFFOLD BRANCHES.
- d. RAISING SHALL CONSIST OF SELECTIVE PRUNING TO PROVIDE VERTICAL CLEARANCE.
- 10. PROPOSED/REPLACEMENT TREES
- a. PRUNING SHALL BE LIMITED TO CLEANIN
- 11. BRUSH SHALL BE CHIPPED AND SPREAD (ONLY WHEN DISEASE OR INSECT INFESTATION IS NOT PRESENT) UNDERNEATH TREES WITHIN THE TREE PROTECTION ZONE TO A MAXIMUM DEPTH OF THREE (3) INCHES, LEAVING THE TRUNK CLEAR OF MULCH.
- 12. CONTRACTOR SHALL BE RESPONSIBLE FOR REMOVING ALL EXCESS DEBRIS ON A DAILY BASIS.

F. FERTILIZAT

- CONTRACTOR SHALL COORDINATE FERTILIZATION PLAN, FOLLOWING BEST MANAGEMENT PRACTICES WITH THE PROJECT ARBORIST PRIOR TO COMMENCEMENT OF WORK.
- 2. EVERY EFFORT SHALL BE MADE TO UTILIZE CHEMICALS OF AN ORGANIC OR BIODEGRADABLE NATURE IN ORDER TO OFFER THE LEAST IMPACT TO THE NATURAL ENVIRONMENT. CONTRACTOR IS RESPONSIBLE FOR MIXING, APPLYING, AND DISPOSAL OF ALL CHEMICALS IN ACCORDANCE WITH STRICT ADHERENCE TO MANUFACTURER'S SPECIFICATIONS. COORDINATE WITH PROJECT ARBORIST FOR FURTHER INSTRUCTION.
- 3. ONLY TREES AFFECTED BY CONSTRUCTION OR AS SHOWN ON THE TREE MITIGATION PLAN AND TREE INVENTORY SCHEDULE
- 4. TREES SPECIFIED TO RECEIVE FERTILIZER SHALL BE TREATED AS FOLLOWS.
 - a. MIX FERTILIZER ACCORDING TO MANUFACTURER'S SPECIFICATIONS INTO A TANK WITH AGITATION CAPABILITY.
 - b. MIX WETTING AGENT ACCORDING TO MANUFACTURER'S SPECIFICATIONS INTO SAME TANK WITH FERTILIZER. AGITATE MIX.
 - c. INJECT THE MIXTURE WITH A HYDRAULIC INJECTION SYSTEM INTO THE UPPER 6-12 INCHES OF SOIL WITH A SOIL PROBE. INJECT AT THE RATE OF ONE THIRD (1/3) GALLON AT EACH INJECTION SITE.
 - d. THE CRITICAL ROOT ZONE AREA PLUS 2' BEYOND THE CRITICAL ROOT ZONE SHALL BE INJECTED, BUT NOT BEYOND ROOT PRUNING LOCATIONS.
 - e. FERTILIZER SHALL BE INSTALLED PRIOR TO THE INSTALLATION OF ANY AERATION SYSTEMS.
 - f. EMPTY PRODUCT CONTAINERS SHALL BE STOCKPILED FOR INSPECTION BY THE PROJECT ARBORIST PRIOR TO DISPOSAL

G. INSECTICIDE

- 7. NOTIFY PROJECT ARBORIST IF ANY INFESTATION IS NOTICED.
- 8. FOLLOW PROJECT ARBORIST'S RECOMMENDED PROCEDURES.
- 6. FOLLOW ALL MANUFACTURERS' RECOMMENDATIONS CONCERNING APPLICATION. READ ALL WARNING LABELS.
- 10. ANY PETS, AS WELL AS, THE PETS FOOD AND WATER BOWLS SHOULD BE REMOVED FROM THE AREA AND ANY SWIMMING POOLS SHOULD BE COVERED. COORDINATE WITH PROJECT ARBORIST FOR FURTHER INSTRUCTION.
- 11. ENSURE COMPLETE COVERAGE AND REAPPLY 2-3 MONTHS AFTER INITIAL APPLICATION UTILIZING SAME PROCEDURE.

H. IRRIGATION

- EVERY EFFORT SHALL BE MADE TO WATER THE PRESERVED TREES AND TRANSPLANTS. CONTRACTOR SHALL IRRIGATE BY HAND OR BY TEMPORARY IRRIGATION.
- 2. IRRIGATE AS REQUIRED BY PROJECT ARBORIST UNTIL PERMANENT IRRIGATION IS INSTALLED AND OPERATING.
- 3. UNDERGROUND IRRIGATION SHALL NOT BE INSTALLED WITHIN THE DRIP LINES OF EXISTING TREES UNLESS ROOT PROTECTION MEASURES ARE PROVIDED AND APPROVED BY PROJECT ARBORIST.

I. TREE REMOVALS

- PRIOR TO AND DURING LAND CLEARING, INCLUDING GRUBBING, ALL TREES TO BE REMOVED SHALL BE CLEARLY MARKED BY PROJECT ARBORIST WITH RED SURVEY RIBBONS AT 36 INCHES MINIMUM ABOVE GRADE.
- 2. CONTRACTOR SHALL REMOVE ALL TREES AS SHOWN ON THE TREE MITIGATION PLANS AFTER THE TREE PROTECTION FENCING IS INSTALLED.

ALL TREES SHOWN TO BE REMOVED SHALL BE FELLED WITH A CHAIN SAW AND STUMP GROUND 6" BELOW SURFACE. ANY TREE

- SHOWN TO BE REMOVED THAT IS IN AN AREA WHERE COMPACTION IS CRITICAL SHALL BE FELLED WITH A CHAIN SAW AND STUMP REMOVED BY CONTRACTOR.

 4. ALL WOOD AND STUMPS FROM REMOVALS SHALL BE HAULED FROM THE SITE THE SAME DAY, EXCEPT FOR TOPS, ALL TOPS ARE TO
 - BE MULCHED AND STOCKPILED OR HAULED DIRECTLY TO MULCHED AREAS FOR RELOCATED TREES IF SCHEDULING PERMITS. TOPS

SHALL BE CHIPPED AND PLACED IN THE TREE PROTECTION ZONE TO A DEPTH OF THREE (3) INCHES. ALL EXCESS WOOD CHIPS SHOULD BE HAULED OFF SITE AFTER TRANSPLANTING IS COMPLETE.

- 5. ALL BURN PITS IF APPLICABLE MUST BE APPROVED BY THE PROJECT ARBORIST AND OWNER.
- 6. TREES TO BE REMOVED THAT HAVE BRANCHES EXTENDING INTO THE CANOPY OF TREES TO REMAIN MUST BE REMOVED BY A QUALIFIED ISA CERTIFIED ARBORIST AND NOT BY DEMOLITION OR CONSTRUCTION CONTRACTORS. THE QUALIFIED ARBORIST SHALL REMOVE THE TREE IN A MANNER THAT CAUSES NO DAMAGE TO THE TREES AND UNDERSTORY VEGETATION TO REMAIN.
- 7. TREES TO BE REMOVED LOCATED WITHIN THE TREE PROTECTION ZONE SHALL BE REMOVED BY A QUALIFIED ISA CERTIFIED ARBORIST. THE TREES SHALL BE CUT NEAR GROUND LEVEL AND THE STUMP GROUND OUT.

L. TOPSOIL

- 10. CONTRACTOR SHALL COORDINATE ALL EARTHWORK OPERATIONS WITHIN TREE PROTECTION AREAS WITH THE PROJECT ARBORIST PRIOR TO BEGINNING WORK.
- 11. ALL TOPSOIL SHALL BE NATURAL, FRIABLE, FERTILE, FINE LOAMY SOIL POSSESSING CHARACTERISTICS OF REPRESENTATIVE TOPSOIL IN THE VICINITY THAT PRODUCES HEAVY GROWTH.
- 12. TOPSOIL, PH RANGE OF 5.5 TO 7.0, 3-5 PERCENT ORGANIC MATERIAL MINIMUM, FREE FROM SUBSOIL, OBJECTIONABLE WEEDS, LITTER, SODS, STIFF CLAY, STONES LARGER THAN ONE (1) INCH IN DIAMETER, STUMPS, ROOTS, TRASH, TOXIC SUBSTANCES, OR ANY OTHER MATERIAL WHICH MAY BE HARMFUL TO PLANT GROWTH.
- 13. VERIFY AMOUNT STOCKPILED IF ANY, AND SUPPLY ADDITIONAL AS NEEDED FROM NATURALLY WELL-DRAINED SITES WHERE TOPSOIL OCCURS AT LEAST FOUR (4) INCHES DEEP. DO NOT OBTAIN TOPSOIL FROM BOGS OR MARSHES.
- 14. PROJECT ARBORIST SHALL APPROVE ALL TOPSOIL PRIOR TO PLACEMENT.

M. REPAIR OF DAMAGED TREES

- . IF DAMAGE TO ANY TREE SHOULD OCCUR BY ACCIDENT OR NEGLIGENCE DURING THE CONSTRUCTION PERIOD, THE PROJECT ARBORIST SHALL APPRAISE THE DAMAGE AND MAKE RECOMMENDATIONS TO THE OWNER FOR REPAIR BY THE CONTRACTOR.
- IF ANY TREE DESIGNATED TO BE SAVED IS REMOVED FROM THE SITE WITHOUT PERMISSION OF THE OWNER'S REPRESENTATIVE, THE PROJECT ARBORIST SHALL APPRAISE THE TREE AND MAKE RECOMMENDATIONS TO THE OWNER FOR REPLACEMENT BY THE CONTRACTOR. THE CONTRACTOR SHALL BE RESPONSIBLE FOR REPLACEMENT OF THE TREE AND ANY FEES THAT MAY BE ASSESSED TO THE OWNER BY THE GOVERNING AGENCY.

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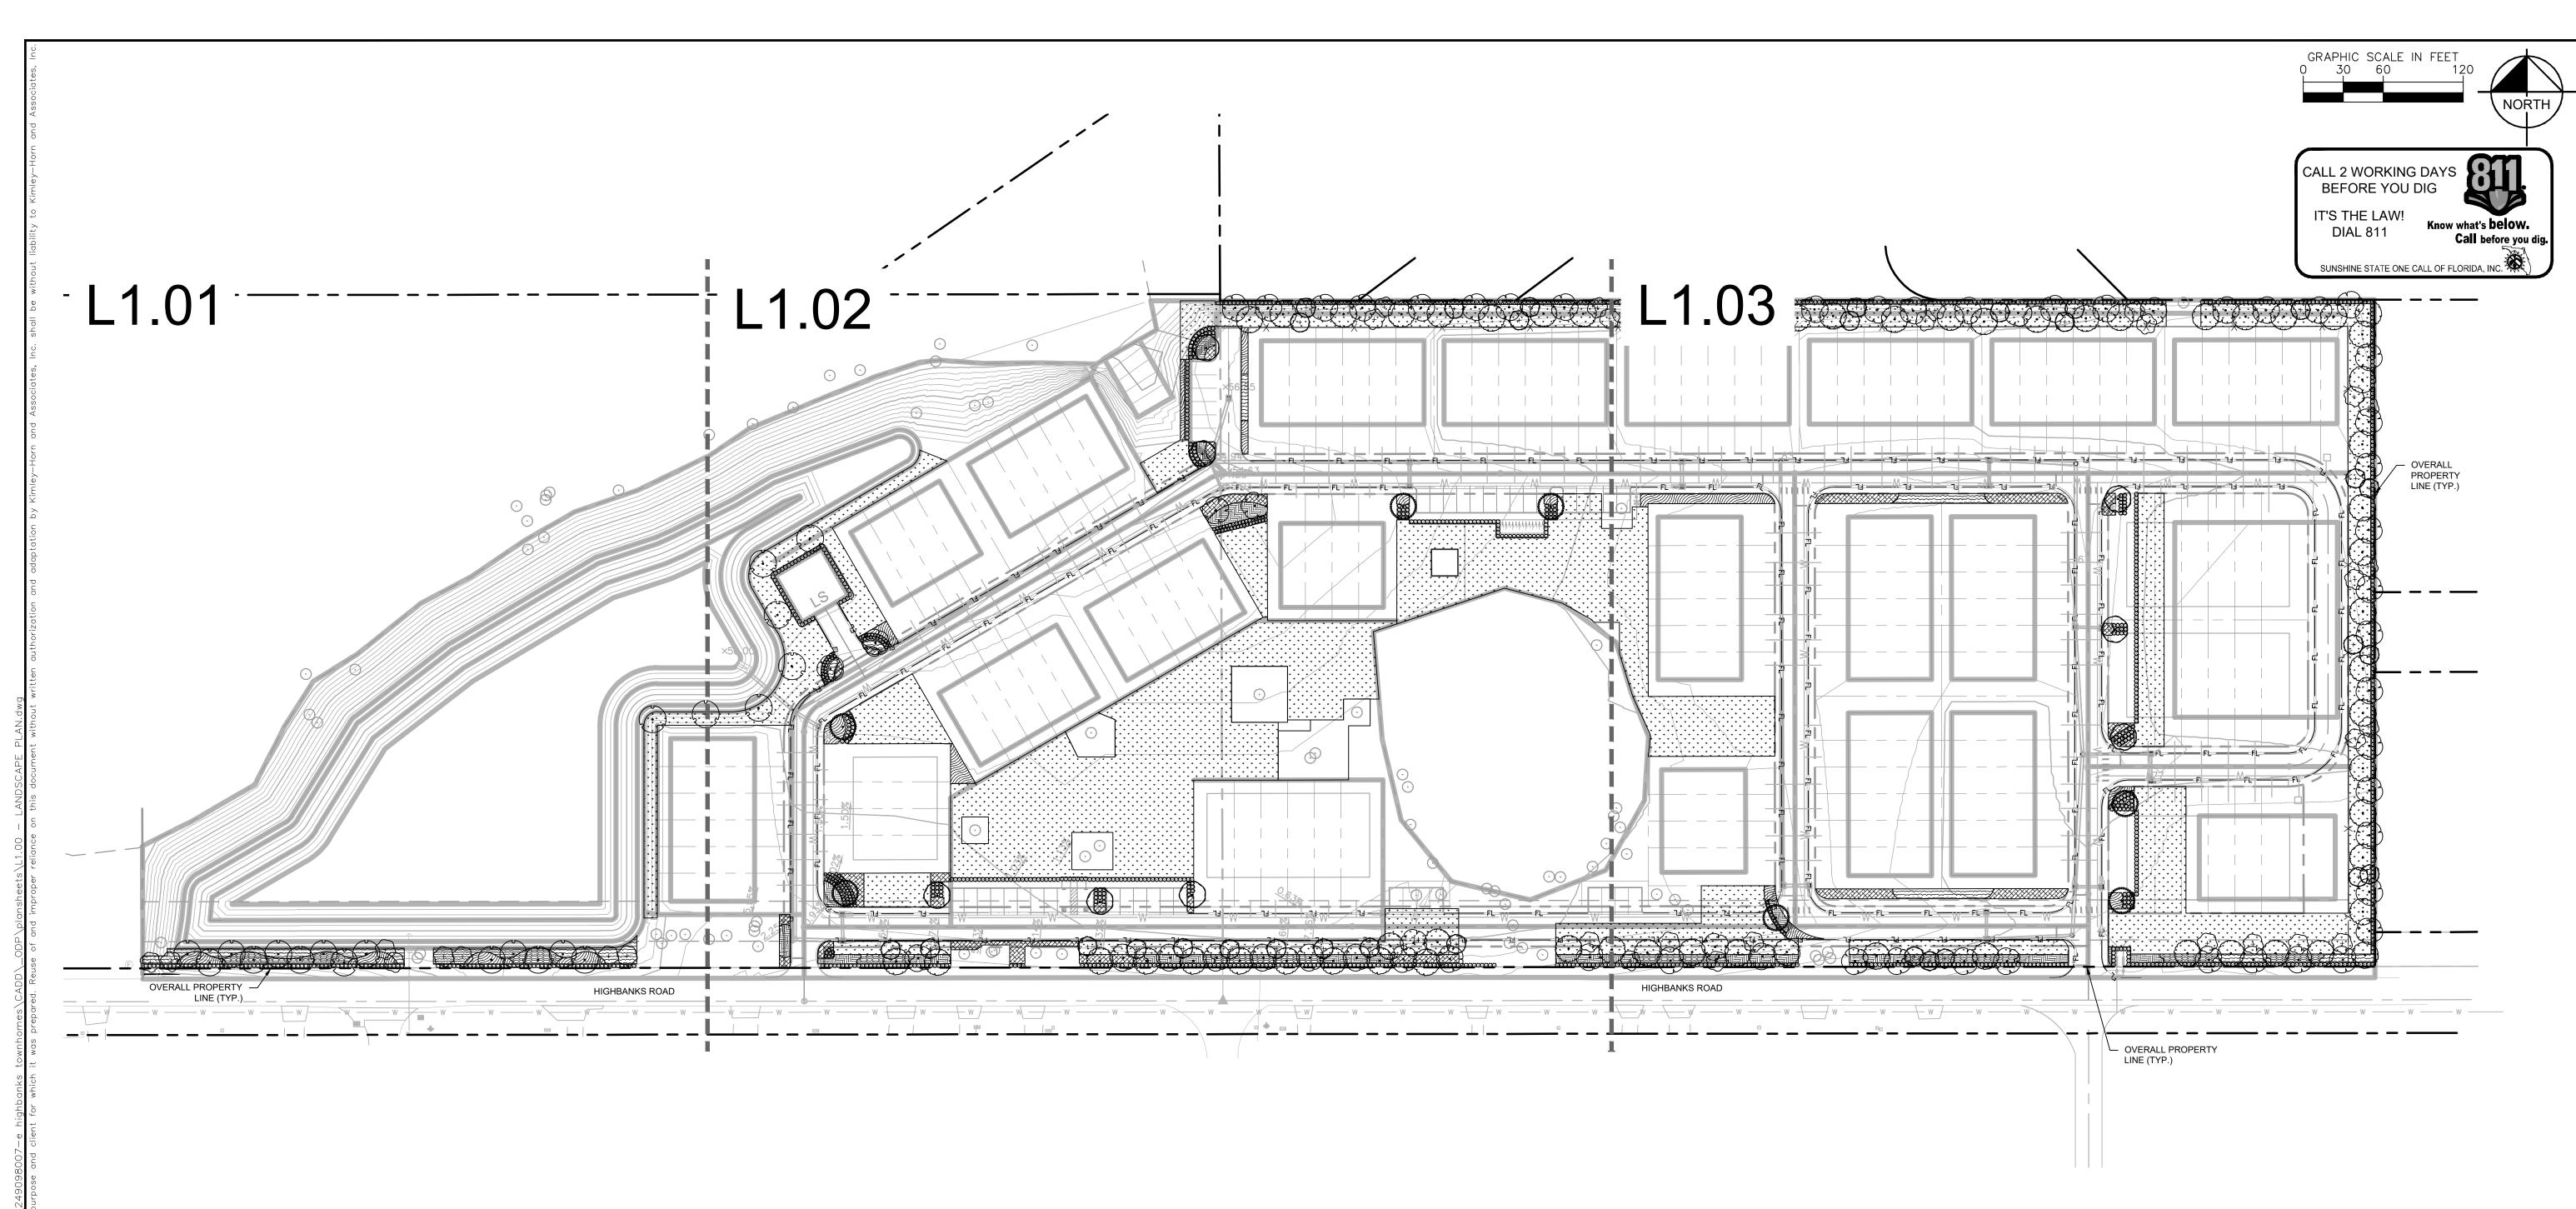
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IGE AVENUE, SUITE 1000, ORLANDO, FL 32801
PHONE: 407-898-1511

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SHEET NUMBER

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1 TYPICAL TREE MITIGATION NOTES



LANDSCAPE NOTES:

- ALL LANDSCAPE MATERIAL TO BE FLORIDA GRADE #1 OR BETTER QUALITY
- 2. ALL LANDSCAPED AREAS ARE TO RECEIVE A MINIMUM OF 4" OF TOPSOIL.
- 3. ALL PLANT MATERIAL SHALL BE HEALTHY, VIGOROUS, AND FREE OF PESTS AND DISEASE.
- 4. ALL MATERIALS ARE SUBJECT TO THE APPROVAL OF THE LANDSCAPE ARCHITECT BEFORE, DURING, AND AFTER INSTALLATION.
- 5. ALL TREES MUST BE GUYED OR STAKED AS SHOWN IN THE DETAILS.
- 6. ALL PLANTING AREAS SHALL BE COMPLETELY MULCHED AS SPECIFIED.
- 7. PRIOR TO CONSTRUCTION, THE CONTRACTOR SHALL BE RESPONSIBLE FOR LOCATING ALL UNDERGROUND UTILITIES AND SHALL AVOID DAMAGE TO ALL UTILITIES DURING THE COURSE OF THE WORK. LOCATIONS OF EXISTING BURIED UTILITY LINES SHOWN ON THE PLANS ARE BASED UPON BEST AVAILABLE INFORMATION AND ARE TO BE CONSIDERED APPROXIMATE. IT SHALL BE THE RESPONSIBILITY OF THE CONTRACTOR 1) TO VERIFY THE LOCATIONS OF UTILITY LINES ADJACENT TO THE WORK AREA 2) TO PROTECT ALL UTILITY LINES DURING THE CONSTRUCTION PERIOD 3) TO REPAIR ANY AND ALL DAMAGE TO UTILITIES, STRUCTURES, SITE APPURTENANCES, ETC. WHICH OCCURS AS A RESULT OF THE CONSTRUCTION.
- 8. THE CONTRACTOR SHALL BE RESPONSIBLE FOR VERIFYING ALL QUANTITIES SHOWN ON THESE PLANS BEFORE PRICING THE WORK.
- 9. CONTRACTOR SHALL BE RESPONSIBLE FOR DELIVERY SCHEDULE AND PROTECTION BETWEEN DELIVERY AND PLANTING TO MAINTAIN HEALTHY PLANT CONDITIONS
- 10. THE CONTRACTOR SHALL BE RESPONSIBLE FOR FULLY MAINTAINING (INCLUDING BUT NOT LIMITED TO: WATERING, SPRAYING,

MULCHING, FERTILIZING, ETC.) ALL OF THE PLANT MATERIALS AND LAWN FOR THE WARRANTY PERIOD.

- 11. ANY PLANT MATERIAL WHICH IS DISEASED, DISTRESSED, DEAD, OR REJECTED (PRIOR TO SUBSTANTIAL COMPLETION) SHALL BE PROMPTLY REMOVED FROM THE SITE AND REPLACED WITH MATERIAL OF THE SAME SPECIES, QUANTITY, AND SIZE AND MEETING ALL PLANT LIST SPECIFICATIONS.
- 12. THE CONTRACTOR SHALL COMPLETELY GUARANTEE ALL PLANT MATERIAL FOR WARRANTY PERIOD. THE CONTRACTOR SHALL PROMPTLY MAKE ALL REPLACEMENTS DURING THE NORMAL PLANTING SEASON.
- 13. STANDARDS SET FORTH IN "AMERICAN STANDARD FOR NURSERY STOCK" REPRESENT GUIDELINE SPECIFICATIONS ONLY AND SHALL CONSTITUTE MINIMUM QUALITY REQUIREMENTS FOR PLANT MATERIAL.
- 14. ALL LANDSCAPING SHALL BE INSTALLED ACCORDING TO SOUND NURSERY PRACTICES, AND SHALL BE FLORIDA NO. 1 OR BETTER AS GIVEN IN "GRADES AND STANDARDS FOR NURSERY PLANTS, PARTS I AND II," STATE OF FLORIDA, DEPARTMENT OF AGRICULTURE.
- 15. ALL INVASIVE / EXOTIC SPECIES AND PROHIBITED TREE SPECIES SHALL BE REMOVED FROM SITE, INCLUDING ROOT BALLS TO THE EXTENT POSSIBLE WITH NO DAMAGE TO ADJACENT EXISTING TREES.
- 16. ALL LANDSCAPE AREAS WILL BE PROVIDED WITH PERMANENT AUTOMATIC IRRIGATION SYSTEM.
- 17. TREE SUPPORT MATERIALS ARE TO BE REMOVED FROM EACH TREE ONCE IT IS "ESTABLISHED" (AS APPROVED BY THE LANDSCAPE ARCHITECT).
- 18. ALL PLANT SPECIFICATIONS IN THE PLANT SCHEDULE SHALL BE CONSIDERED THE MINIMUM ALLOWABLE SPECIFICATIONS. CONTRACTOR SHALL PROCURE PLANT MATERIALS AND UPSIZE AS NECESSARY TO MEET THE MOST STRINGENT SPECIFICATION.

PLANT SCHEDULE							
CANOPY TREE	CODE	QTY	BOTANICAL / COMMON NAME	CONT	CAL	SIZE	
00000000000000000000000000000000000000	LS	7	LIQUIDAMBAR STYRACIFLUA / SWEET GUM NATIVE, FL #1, STRAIGHT, SINGLE TRUNK, CLEAR TRUNK	FG	3" CAL MIN	12` HT	
	MG	63	MAGNOLIA GRANDIFLORA / SOUTHERN MAGNOLIA NATIVE, FL #1, STRAIGHT, SINGLE TRUNK, CLEAR TRUNK	FG	3" CAL MIN	12` HT	
	QS	8	QUERCUS SHUMARDII / SHUMARD OAK NATIVE, FL #1, STRAIGHT, SINGLE TRUNK, CLEAR TRUNK	FG	3" CAL MIN	12` HT	
	QV	62	QUERCUS VIRGINIANA / SOUTHERN LIVE OAK NATIVE, FL #1, STRAIGHT, SINGLE TRUNK, CLEAR TRUNK	FG	3" CAL MIN	12` HT	
	TD	21	TAXODIUM DISTICHUM / BALD CYPRESS FL #1, STRAIGHT, SINGLE TRUNK, FULL	FG	3" CAL MIN	12` HT	
UNDERSTORY TREES	CODE	<u>QTY</u>	BOTANICAL / COMMON NAME	CONT	<u>CAL</u>	<u>SIZE</u>	
+	IA	31	ILEX OPACA / AMERICAN HOLLY NATIVE, STRAIGHT, SINGLE LEADER	FG	2" CAL MIN	8` HT	
+	JS	31	JUNIPERUS VIRGINIANA SILICICOLA / SOUTHERN REDCEDAR NATIVE, STRAIGHT, SINGLE LEADER	FG	2" CAL MIN	8` HT	
SHRUBS	CODE	QTY	BOTANICAL / COMMON NAME	CONT	SPACING	SIZE	
\bigcirc	IN	136	ILEX VOMITORIA 'NANA' / DWARF YAUPON HOLLY FULL	3 GAL	30" OC	24" HT	
\bigcirc	PM	940	PODOCARPUS MACROPHYLLUS / YEW PODOCARPUS FULL	7 GAL	36" OC	36" HT	
0	RI	179	RHAPHIOLEPIS INDICA / INDIAN HAWTHORN FULL	3 GAL	30" OC	36" HT	
\odot	VO	224	VIBURNUM ODORATISSIMUM / SWEET VIBURNUM FULL	3 GAL	36" OC	36" HT	
GROUND COVERS	CODE	<u>QTY</u>	BOTANICAL / COMMON NAME	CONT	<u>SIZE</u>	SPACING	
	AE	4,100 SF	ASPIDISTRA ELATIOR / CAST IRON PLANT FULL	1 GAL	12" FULL	18" OC	
	HF	3,812 SF	HEMEROCALLIS FULVA / ORANGE DAYLILY FULL	1 GAL	12" FULL	18" OC	
	OJ	3,476 SF	OPHIOPOGON JAPONICUS / MONDO GRASS FULL	1 GAL	12" FULL	18" OC	

	TC	4,714 SF	TRACHELOSPERMUM JASMINOIDES 'CONFEDERATE' / CONFEDERATE JASMINE FULL	1 GAL	12" FULL	18" OC
	TV	3,210 SF	TULBAGHIA VIOLACEA / SOCIETY GARLIC FULL	1 GAL	12" FULL	18" OC
SOD	CODE	QTY	BOTANICAL / COMMON NAME	CONT	SIZE	SPACING
* * * * * * * * * * * * * * * * * * *	PN	109,158 SF	PASPALUM NOTATUM / BAHIAGRASS ROLLED TIGHT, 100% WEED/INSECT/DISEASE FREE	SOD	-	-


MISC. QTY BOTANICAL/COMMON NAME

MULCH TBD DESIGNER BROWN HARDWOOD MULCH

3" DEPTH MINIMUM, SHREDDED, FREE OF WEEDS/INVASIVE PLANT MATERIAL

LANDSCAPE CALCULATIONS PER "DEBARY" LAND DEVELOPMENT CODE					
	REQUIRED	PROVIDED			
BUFFERYARD MIN. 20' WIDTH, 2 CANOPY TREE PER 40 LF, 2 UNDERSTORY TREE PER 80 LF, CONTINUOUS SCREEN TO BE 6' HT SECTION 5-4, 5-10	NORTH BUFFER: 843 LF 42 CANOPY TREES, 20 UNDERSTORY TREES, CONTINUOUS SCREEN EAST BUFFER: 491 LF 24 CANOPY TREES, 12 UNDERSTORY TREES, CONTINUOUS SCREEN SOUTH BUFFER 1: 352 LF 16 CANOPY TREES, 8 UNDERSTORY TREES, CONTINUOUS SCREEN SOUTH BUFFER 2: 766 LF 38 CANOPY TREES, 18 UNDERSTORY TREES, CONTINUOUS SCREEN SOUTH BUFFER 3: 197 LF 9 CANOPY TREES, 4 UNDERSTORY TREES, CONTINUOUS SCREEN	NORTH BUFFER: 843 LF 42 CANOPY TREES, 20 UNDERSTORY TREES, CONTINUOUS SCREEN EAST BUFFER: 491 LF 24 CANOPY TREES, 12 UNDERSTORY TREES, CONTINUOUS SCREEN SOUTH BUFFER 1: 352 LF 16 CANOPY TREES, 8 UNDERSTORY TREES, CONTINUOUS SCREEN SOUTH BUFFER 2: 766 LF 38 CANOPY TREES, 18 UNDERSTORY TREES, CONTINUOUS SCREEN SOUTH BUFFER 3: 197 LF 9 CANOPY TREES, 4 UNDERSTORY TREES, CONTINUOUS SCREEN			
VUA REQUIREMENTS: MIN. 140 SF NO MORE THAN 15 PARKING STALLS CONTINUOUSLY SIDE BY SIDE SECTION 5-8	12 ISLANDS PROVIDED X 140 SF MIN = 1,680 SF OF VUA REQUIRED	4,827 SF PROVIDED			
LANDSCAPE REQUIREMENTS: 25% OF SITE TOTAL REQUIRED LANDSCAPE TO BE COVERED WITH SHRUBS, GROUNDCOVERS, VINES -SOD TO BE MIN. 400 SF -VARIETY OF TREE SPECIES	25% REQUIRED -SOD MIN. 400 SF REQUIRED -41+ REQUIRED TREES = 5 SPECIES REQUIRED	SOD: 109,158 SF SHRUBS/GROUNDCOVERS: 33,362 SF = 30.5% TO BE PROVIDED AS SHRUBS/GROUNDCOVERS -SOD MIN. 400 SF PROVIDED -41+ PROVIDED TREES = 5 SPECIES PROVIDED			
SECTION 5-6, 5-10					

SHEET NUMBER

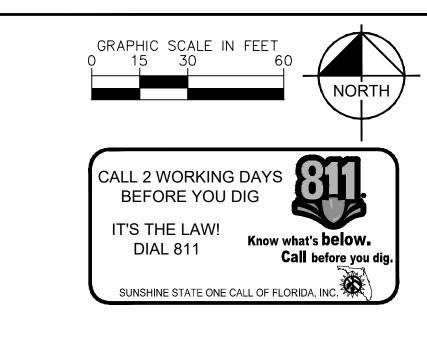



3" DEPTH MINIMUM, SHREDDED, FREE OF WEEDS/INVASIVE PLANT MATERIAL

PLANT SCHEDULE						
CANOPY TREE	CODE	QTY	BOTANICAL / COMMON NAME			
00000000000000000000000000000000000000	LS	7	LIQUIDAMBAR STYRACIFLUA / SWEET GUM NATIVE, FL #1, STRAIGHT, SINGLE TRUNK, CLEAR TRUNK			
	MG	63	MAGNOLIA GRANDIFLORA / SOUTHERN MAGNOLIA NATIVE, FL #1, STRAIGHT, SINGLE TRUNK, CLEAR TRUNK			
	QS	8	QUERCUS SHUMARDII / SHUMARD OAK NATIVE, FL #1, STRAIGHT, SINGLE TRUNK, CLEAR TRUNK			
	QV	62	QUERCUS VIRGINIANA / SOUTHERN LIVE OAK NATIVE, FL #1, STRAIGHT, SINGLE TRUNK, CLEAR TRUNK			
	TD	21	TAXODIUM DISTICHUM / BALD CYPRESS FL #1, STRAIGHT, SINGLE TRUNK, FULL			
UNDERSTORY TREES	CODE	QTY	BOTANICAL / COMMON NAME			
+	IA	31	ILEX OPACA / AMERICAN HOLLY NATIVE, STRAIGHT, SINGLE LEADER			
+	JS	31	JUNIPERUS VIRGINIANA SILICICOLA / SOUTHERN REDCEDAR NATIVE, STRAIGHT, SINGLE LEADER			
SHRUBS	CODE	<u>QTY</u>	BOTANICAL / COMMON NAME			
\odot	IN	136	ILEX VOMITORIA 'NANA' / DWARF YAUPON HOLLY FULL			
\bigcirc	PM	940	PODOCARPUS MACROPHYLLUS / YEW PODOCARPUS FULL			
\odot	RI	179	RHAPHIOLEPIS INDICA / INDIAN HAWTHORN FULL			
\odot	VO	224	VIBURNUM ODORATISSIMUM / SWEET VIBURNUM FULL			
GROUND COVERS	CODE	QTY	BOTANICAL / COMMON NAME			
	AE	4,100 SF	ASPIDISTRA ELATIOR / CAST IRON PLANT FULL			
	HF	3,812 SF	HEMEROCALLIS FULVA / ORANGE DAYLILY FULL			
	OJ	3,476 SF	OPHIOPOGON JAPONICUS / MONDO GRASS FULL			
	тс	4,714 SF	TRACHELOSPERMUM JASMINOIDES 'CONFEDERATE' / CONFEDERATE JASMINE FULL			
	TV	3,210 SF	TULBAGHIA VIOLACEA / SOCIETY GARLIC FULL			
SOD	CODE	QTY	BOTANICAL / COMMON NAME			
, , , , , , , , , , , , , , , , , , ,	PN	109,158 SF	PASPALUM NOTATUM / BAHIAGRASS ROLLED TIGHT, 100% WEED/INSECT/DISEASE FREE			

MULCH TBD DESIGNER BROWN HARDWOOD MULCH

SHEET NUMBER L1.01

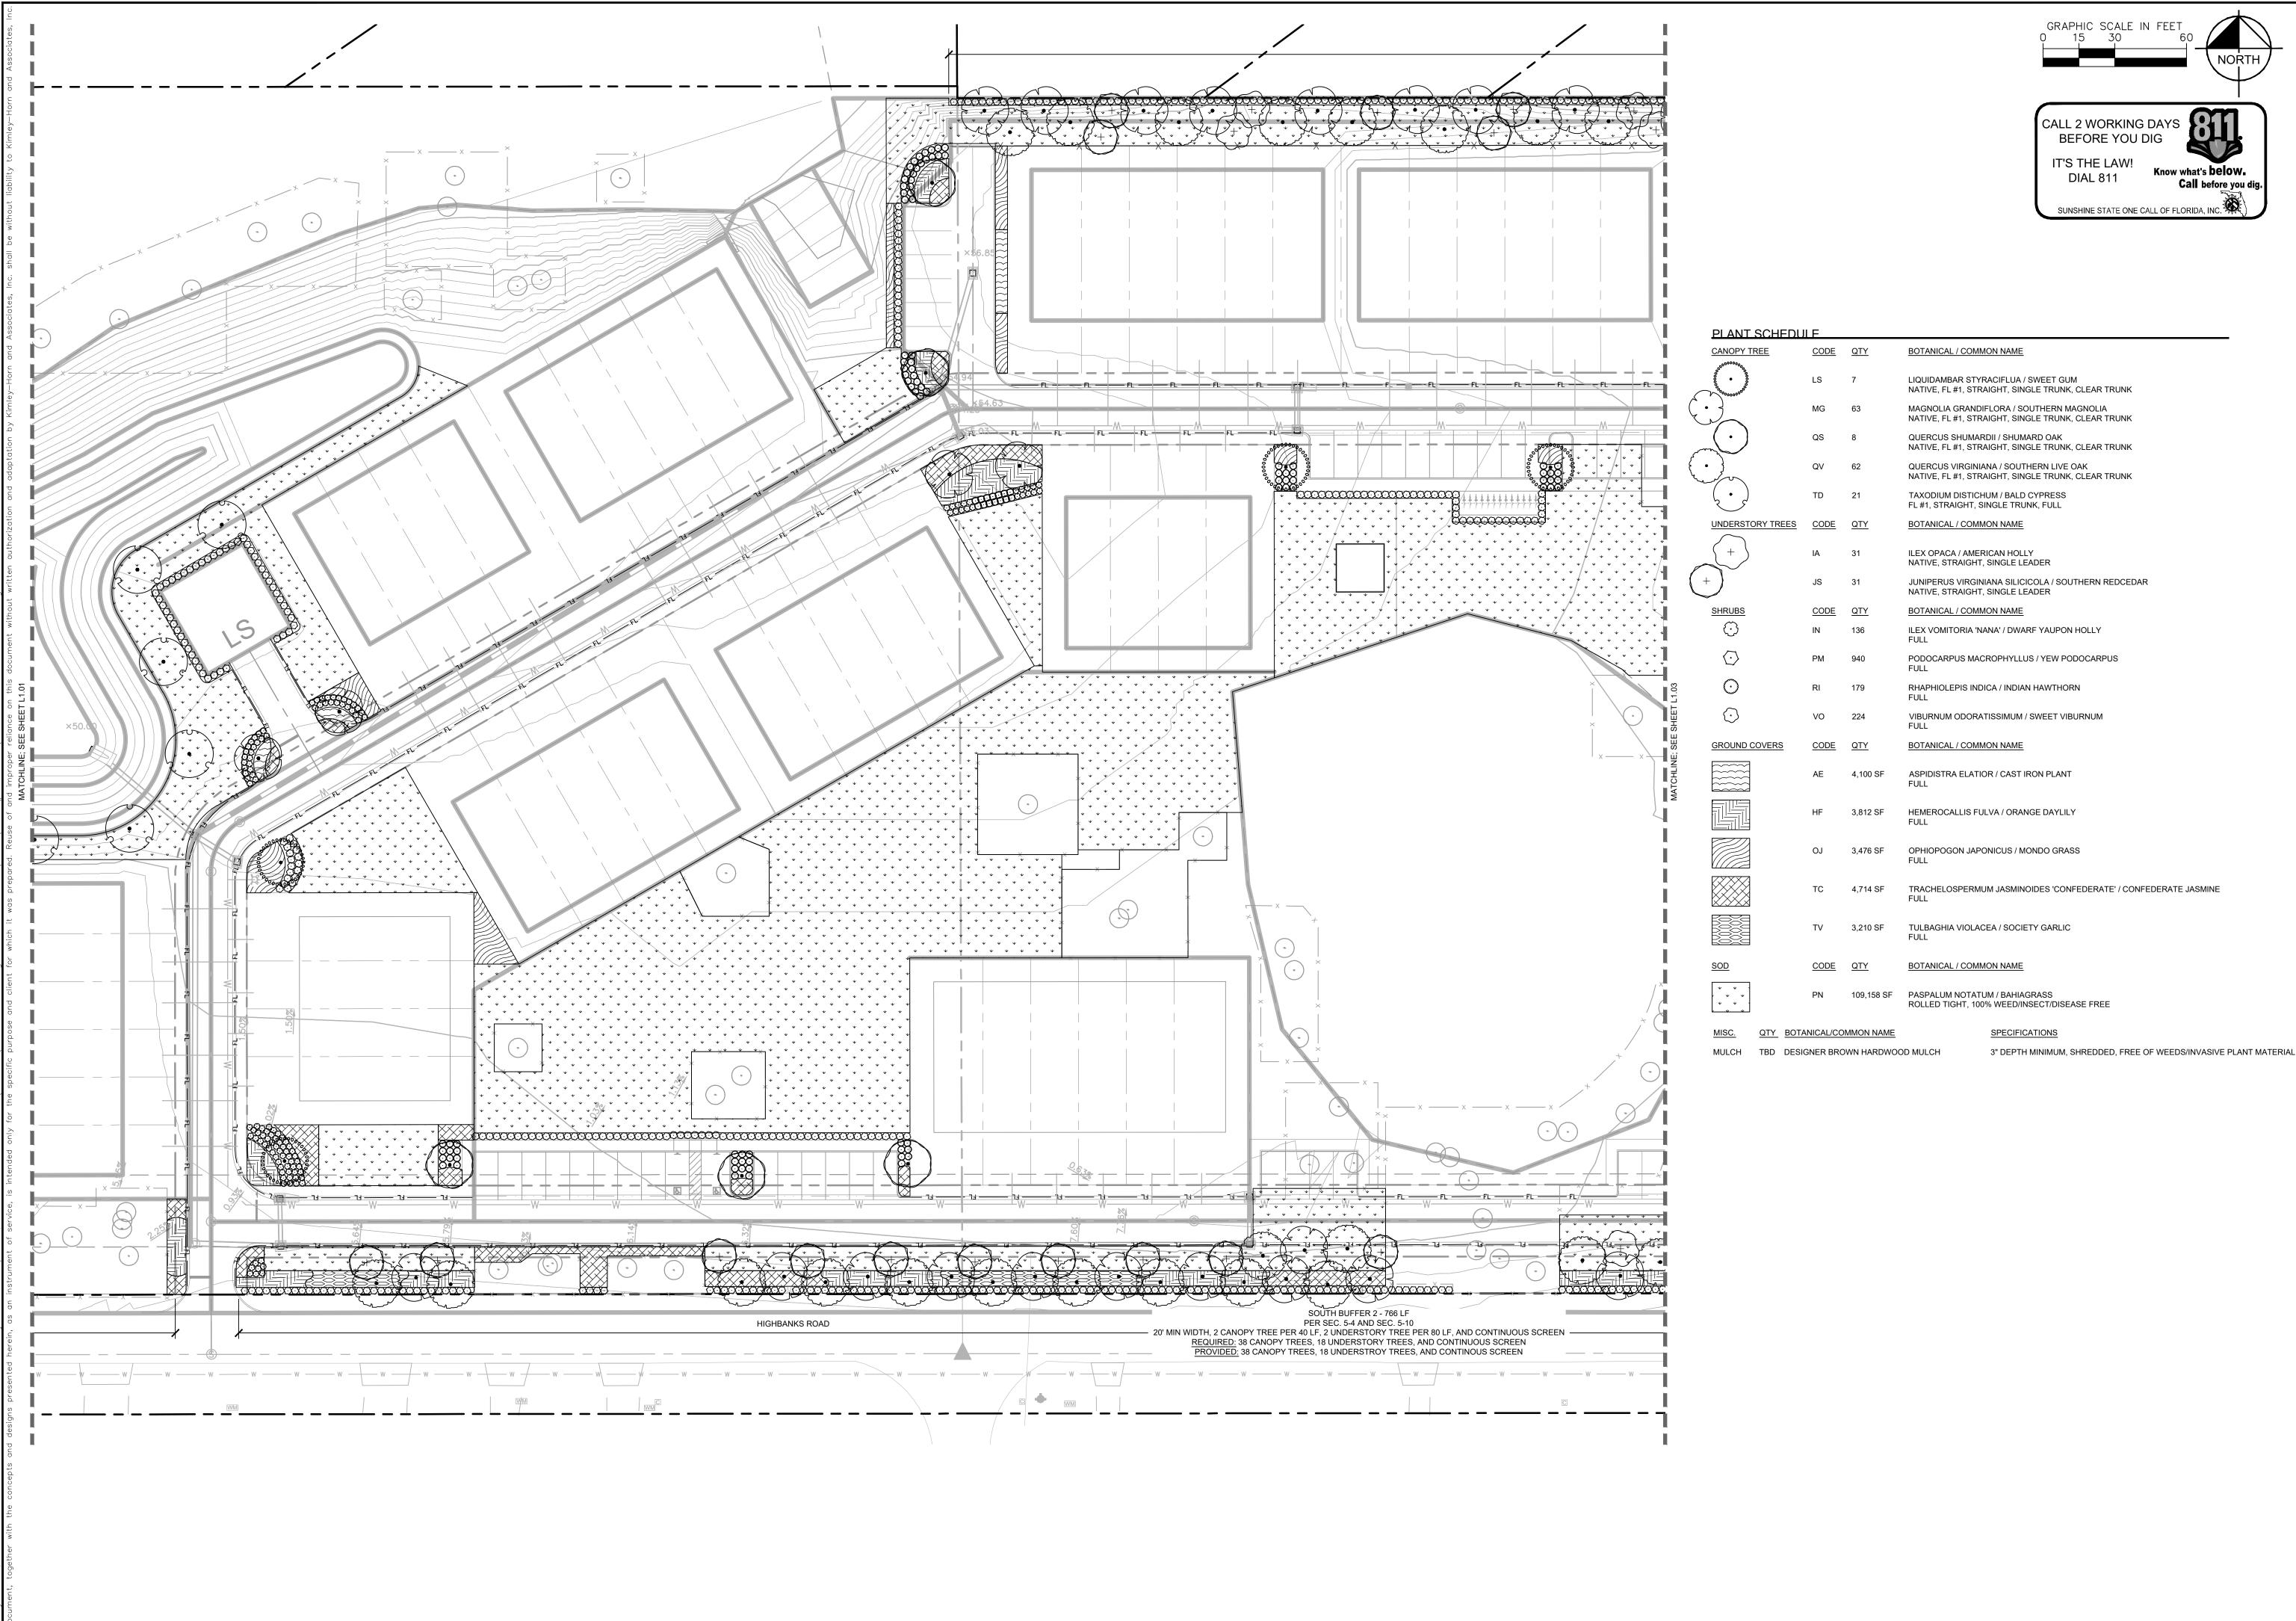


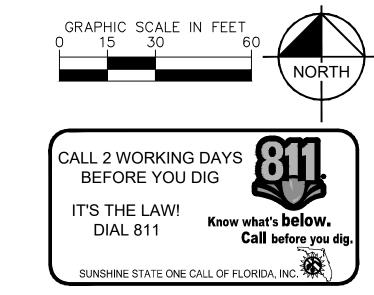

PLANT SCHEDULE				
CANOPY TREE	CODE	QTY	BOTANICAL / COMMON NAME	
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	QS	8	QUERCUS SHUMARDII / SHUMARD OAK NATIVE, FL #1, STRAIGHT, SINGLE TRUNK, CLEAR TRUNK	
	QV	62	QUERCUS VIRGINIANA / SOUTHERN LIVE OAK NATIVE, FL #1, STRAIGHT, SINGLE TRUNK, CLEAR TRUNK	
	TD	21	TAXODIUM DISTICHUM / BALD CYPRESS FL #1, STRAIGHT, SINGLE TRUNK, FULL	
UNDERSTORY TREES	CODE	<u>QTY</u>	BOTANICAL / COMMON NAME	
+	IA	31	ILEX OPACA / AMERICAN HOLLY NATIVE, STRAIGHT, SINGLE LEADER	
$\begin{pmatrix} + \end{pmatrix}$	JS	31	JUNIPERUS VIRGINIANA SILICICOLA / SOUTHERN REDCEDAR NATIVE, STRAIGHT, SINGLE LEADER	
SHRUBS	CODE	<u>QTY</u>	BOTANICAL / COMMON NAME	
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\bigcirc	PM	940	PODOCARPUS MACROPHYLLUS / YEW PODOCARPUS FULL	
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	AE	4,100 SF	ASPIDISTRA ELATIOR / CAST IRON PLANT FULL	
	HF	3,812 SF	HEMEROCALLIS FULVA / ORANGE DAYLILY FULL	
	OJ	3,476 SF	OPHIOPOGON JAPONICUS / MONDO GRASS FULL	
	тс	4,714 SF	TRACHELOSPERMUM JASMINOIDES 'CONFEDERATE' / CONFEDERATE JASMINE FULL	
	TV	3,210 SF	TULBAGHIA VIOLACEA / SOCIETY GARLIC FULL	
SOD	CODE	QTY	BOTANICAL / COMMON NAME	

E HIGHBANK TOWNHOMES

SHEET NUMBER L1.02

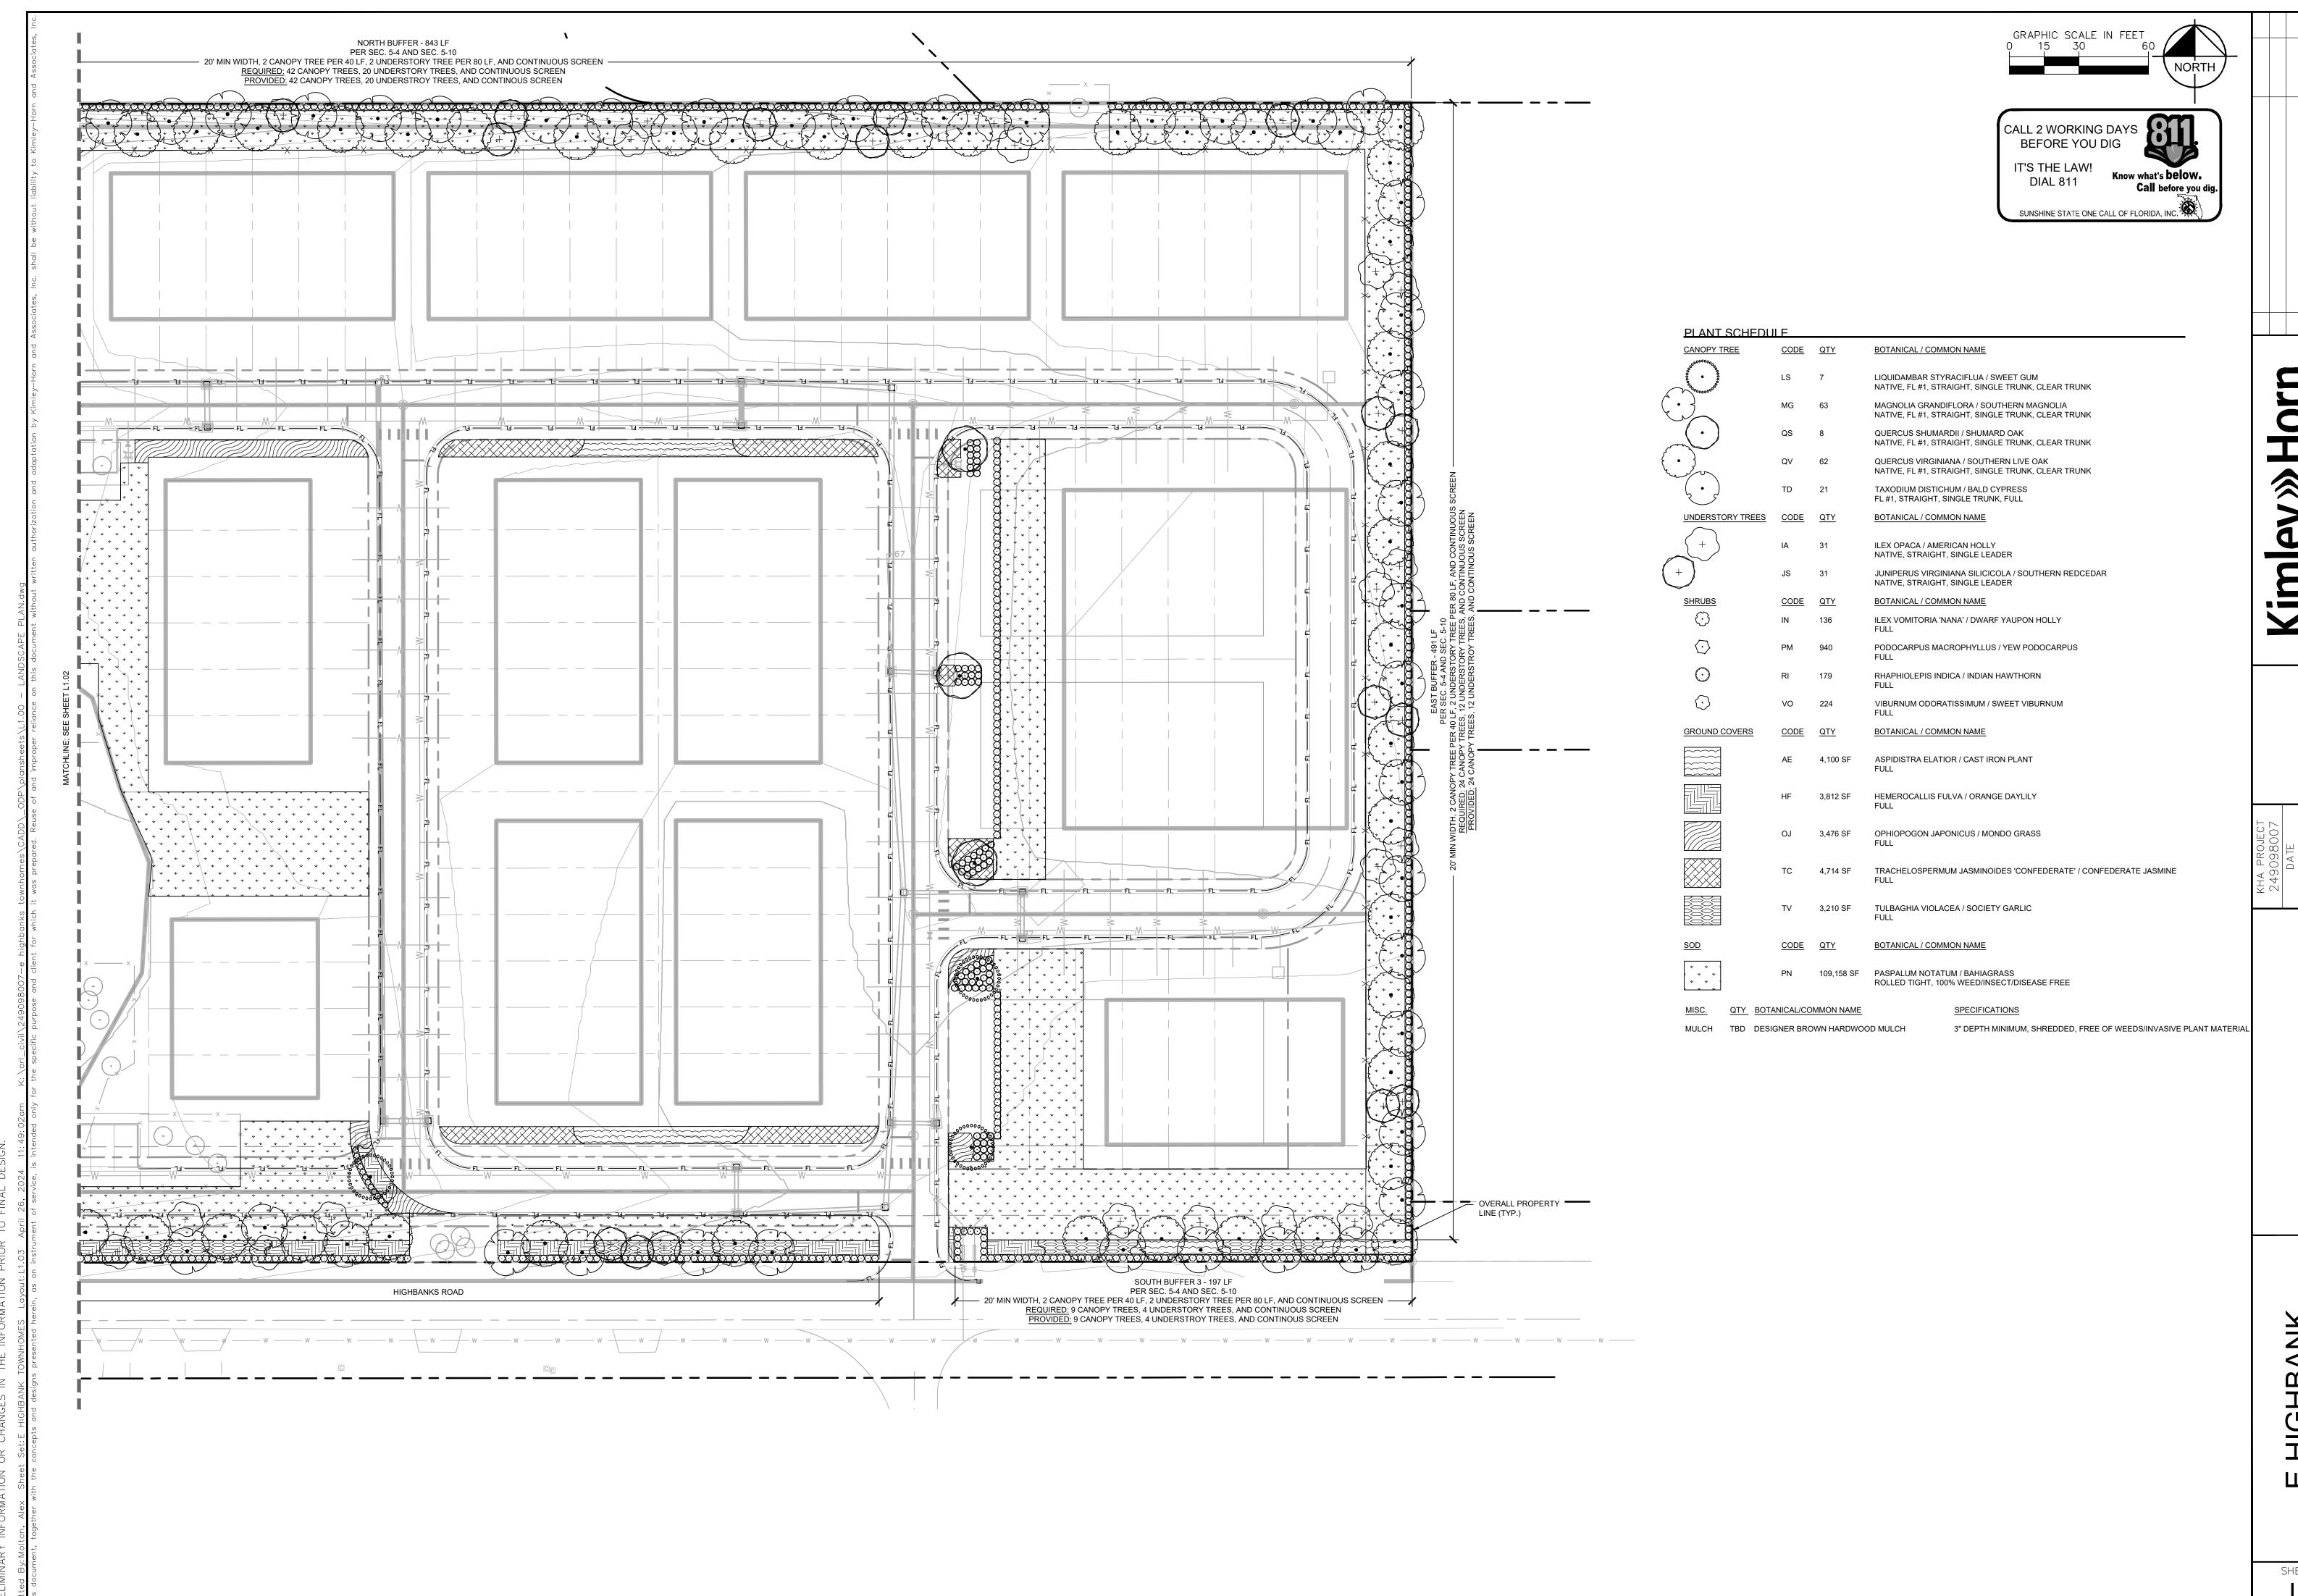

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S. ORANGE AVENUE, SUITE 1000, ORLANDO, FL 33.
PHONE: 407-898-1511

WWW.KIMLEY-HORN.COM REGISTRY NO. 35106

DATE
09.20.23

ALE AS SHOWN
SIGNED BY KHA

PE PLAN SCAL

NDSCAPE PL/

MNHOMES

SHEET NUMBER

(1) TRUNK/ROOT BALL TO BE CENTERED AND PLUMB/LEVEL IN PLANTING PIT.

 $(\,2\,)$ 6" DIA. CLEAR OF MULCH AT TRUNK FLARE. 3" MINIMUM MULCH AS SPECIFIED. WHERE TREES ARE PLACED IN SOD, MULCH RING FOR TREES SHALL BE 6' DIAMETER (MIN.) OR AS DIRECTED BY OWNER'S REPRESENTATIVE.

ig(4ig) 4" HIGH BERM, FIRMLY COMPACTED. TREE FROG ANCHOR SYSTEM INSTALLED PER MANUFACTURER'S RECOMMENDATIONS.

6) FINISHED GRADE. (SEE GRADING PLAN) 7) TOP OF ROOTBALL MIN. 1" ABOVE FINISHED

8) PREPARED PLANTING SOIL AS SPECIFIED. 9) TOP OF ROOTBALL SHALL BE 1" ABOVE FINISHED GRADE. ROOTBALLS GREATER THAN 24" DIAMETER SHALL BE PLACED ON MOUND OF UNDISTURBED SOIL TO PREVENT SETTLING. ROOTBALLS SMALLER THAN 24" IN DIAMETER MAY SIT ON COMPACTED EARTH.

(10) UNDISTURBED NATIVE SOIL. 11) SCARIFY BOTTOM AND SIDES OF PLANTING

FINAL TREE STAKING DETAILS AND PLACEMENT TO BE APPROVED BY OWNER.

REMOVE BURLAP, WIRE AND STRAPS (ANYTHING THAT COULD GIRDLE TREE OR RESTRICT ROOT GROWTH) ON UPPER 1/3 OF ROOTBALL.

PRUNE ALL TREES IN ACCORDANCE WITH ANSI

TREE PLANTING ON A SLOPE

3X ROOTBALL

WIDTH MIN.

MULCH/TOPSOIL BACKFILL -

ROOTBALL AND TRUNK —

TREE STABILIZATION AND —

FERTILIZATION SYSTEM

(1) TRUNK/ROOT BALL TO BE CENTERED AND PLUMB/LEVEL IN PLANTING PIT. (2) 6" DIA. CLEAR OF MULCH AT TRUNK FLARE.

(3) 3. 4" HIGH BERM, FIRMLY COMPACTED. () 3" MINIMUM OF HARDWOOD BARK MULCH AS SPECIFIED. WHERE TREES ARE PLACED IN SOD, MULCH RING FOR TREES SHALL BE 6' DIAMETER (MIN.) OR AS DIRECTED BY OWNER'S REPRESENTATIVE.

(5) TREE FROG ANCHOR SYSTEM INSTALLED PER MANUFACTURER'S RECOMMENDATIONS.

(6) 4" MIN. OF TOPSOIL TO BRING TO FINISHED GRADE. (SEE GRADING PLAN)

7 TOP OF ROOTBALL MIN. 1" ABOVE FINISHED 8 PREPARED PLANTING SOIL AS SPECIFIED. 9) ROOTBALLS GREATER THAN 24" DIAMETER SHALL BE PLACED ON MOUND OF

UNDISTURBED SOIL TO PREVENT SETTLING. ROOTBALLS SMALLER THAN 24" IN DIAMETER MAY SIT ON COMPACTED EARTH. (10) UNDISTURBED NATIVE SOIL.

(11) SCARIFY BOTTOM AND SIDES OF PLANTING (12) CUT BACK SLOPE TO PROVIDE A FLAT SURFACE FOR PLANTING

FINAL TREE STAKING DETAILS AND PLACEMENT TO BE APPROVED BY OWNER.

REMOVE BURLAP, WIRE AND STRAPS (ANYTHING THAT COULD GIRDLE TREE OR RESTRICT ROOT GROWTH) ON UPPER 1/3 OF ROOTBALL.

C. PRUNE ALL TREES IN ACCORDANCE WITH ANSI

BEST FACE OF SHRUB/-**GROUNDCOVER TO FACE** FRONT OF PLANTING BED. REFER TO PLANT SCHEDULE FOR SPACING. MAINTAIN 12" DEAD ZONE AT BED EDGE.

(1) TOP OF SHRUB ROOTBALLS TO BE PLANTED 1" - 2" HIGH WITH SOIL MOUNDING UP TO THE TOP OF ROOTBALL 2) PRUNE ALL SHRUBS TO

ACHIEVE A UNIFORM MASS/HEIGHT. (3) 3" MULCH LAYER AS

SPECIFIED. (4) EXCAVATE ENTIRE BED SPECIFIED FOR GROUNDCOVER

(5) FINISHED GRADE (SEE GRADING PLAN).

6) PREPARED PLANTING SOIL AS SPECIFIED. (SEE LANDSCAPE NOTES) NOTE: WHEN GROUND-COVERS AND SHRUBS USED IN MASSES, ENTIRE BED TO BE AMENDED WITH PLANTING SOIL MIX AS SPECIFIED.

SIDES AND BOTTOM. 8) 4" HIGH BERM FIRMLY COMPACTED.

(9) UNDISTURBED NATIVE SOIL. (10) FERTILIZER TABLETS (MAX 3"

7) SCARIFY OF PLANTING PIT

SECTION


3X ROOT BALL WIDTH

A. CONTRACTOR SHALL ASSURE PERCOLATION OF ALL PLANTING PITS PRIOR TO INSTALLATION.

B. WHEN SHRUBS ARE PRUNED IN MASSES, PRUNE ALL SHRUBS TO ACHIEVE UNIFORM MASS / HEIGHT.

C. ALL SHRUBS AND GROUNDCOVERS SHALL BE PLUMB VERTICALLY, UNLESS OTHERWISE DIRECTED BY OWNERS REPRESENTATIVE.

SHRUB/GROUNDCOVER PLANTING

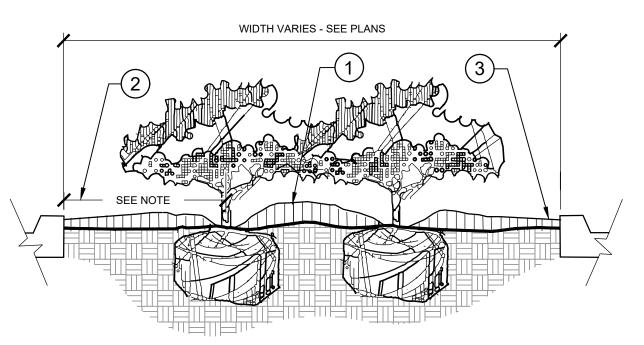

(1) CROWN ISLANDS @ 5:1 SLOPES (OR AS SPECIFIED ON THE LANDSCAPE PLANS).

(3) 2" MIN VERTICAL CLEARANCE, TOP OF CURB TO TOP OF MULCH.

(2) CLEAR ZONE: 36" MIN. FROM BACK OF CURB TO CENTER OF NEAREST SHRUB. CLEAR ZONE SHALL CONTAIN 3" CONTINUOUS MULCH OR TURF, SEE PLANS.

A. EXCAVATE A CONTINUOUS 24" DEEP PIT (FROM TOP OF CURB) FOR ENTIRE LENGTH AND WIDTH OF ISLAND & BACKFILL WITH APPROVED PLANTING MIX.

B. PROTECT AND RETAIN ALL CURBS AND BASE. COMPACTED SUBGRADE TO REMAIN FOR STRUCTURAL SUPPORT OF CURB SYSTEM (TYP).

C. ALL ISLANDS SHALL UTILIZE POOR DRAINAGE DETAIL WHEN PERCOLATION RATES ARE 2" PER HOUR

MIN. 15' CLEAR

SECTION

PLANTED PARKING LOT ISLANDS/MEDIANS

MIN. ½ MATURE

SHRŪB WIDTH

MIN. ½ MATURE

SHRUB WIDTH

- FIRE HYDRANT

(1) FIRE HYDRANT.

2) NO PLANT EXCEEDING 12" MATURE HEIGHT

PLACED WITHIN SHOWN

MATERIAL SHALL BE

RADIUS OF ALL

FIRE HYDRANTS.


(3) FRONT OF HYDRANT

(TOWARD CURB)

CONTRACTOR SHALL ADJUST PLANT

MATERIAL SO THAT NO

CONFLICTS WITH FIRE HYDRANTS OCCUR ON

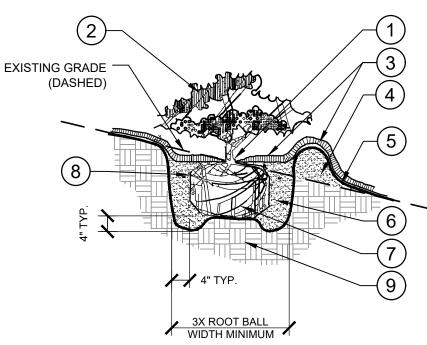

- A. CONTRACTOR SHALL ASSURE PERCOLATION OF ALL PLANTING PITS PRIOR TO INSTALLATION.
- B. WHEN SHRUBS ARE PRUNED IN MASSES, PRUNE ALL SHRUBS TO (9) UNDISTURBED NATIVE SOIL ACHIEVE UNIFORM MASS / HEIGHT.

SHRUB/GROUNDCOVER PLANTING ON A SLOPE

ALL SHRUBS AND GROUNDCOVERS SHALL BE PLUMB VERTICALLY, UNLESS OTHERWISE DIRECTED BY OWNERS REPRESENTATIVE.

- 1) TOP OF SHRUB ROOTBALLS TO BE PLANTED 1" - 2" HIGH WITH SOIL MOUNDING UP TO THE TOP OF) PRUNE SHRUBS AS DIRECTED BY
- OWNER'S REPRESENTATIVE. 3) 3" MINIMUM OF MULCH AS SPECIFIED. WHERE SHRUBS ARE PLACED IN MASSES, MULCH SHALL BE SPREAD IN A CONTINUOUS BED.) SOIL BERM TO HOLD WATER. TOP OF PLANTING PIT 'BERM' TO BE LEVEL ACROSS PIT. SLOPE DOWNHILL PORTION OF BERM AS
- (5) FINISHED GRADE (SEE GRADING
- SPECIFIED. (SEE LANDSCAPE (7) SCARIFY SIDES AND BOTTOM OF
- PLANTING PIT. (8) FERTILIZER TABLETS (MAX 3"



1. CLEAR ZONE: 36" MIN. FROM BUILDING TO CENTER OF NEAREST SHRUB.

24" MIN. CLEAR


2. INSTALL SPECIFIED MULCH: 24" MIN. FROM BUILDING. SPECIFIED MULCH TO BE INSTALLED AT A DEPTH OF 3" (MIN.)

MIN. 1/2


MATURE


SHRUB WIDTH




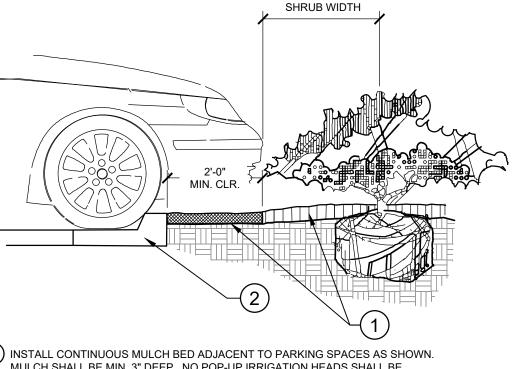



MIN. 1/2 MATURE

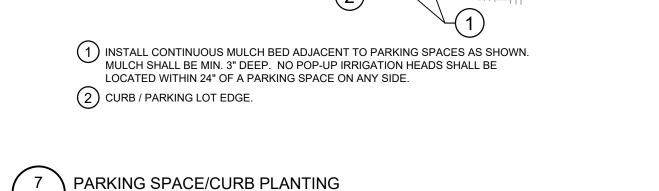

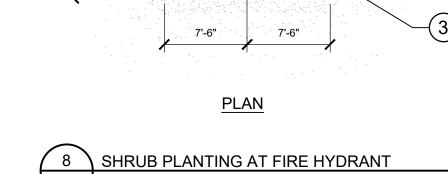

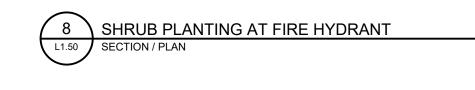

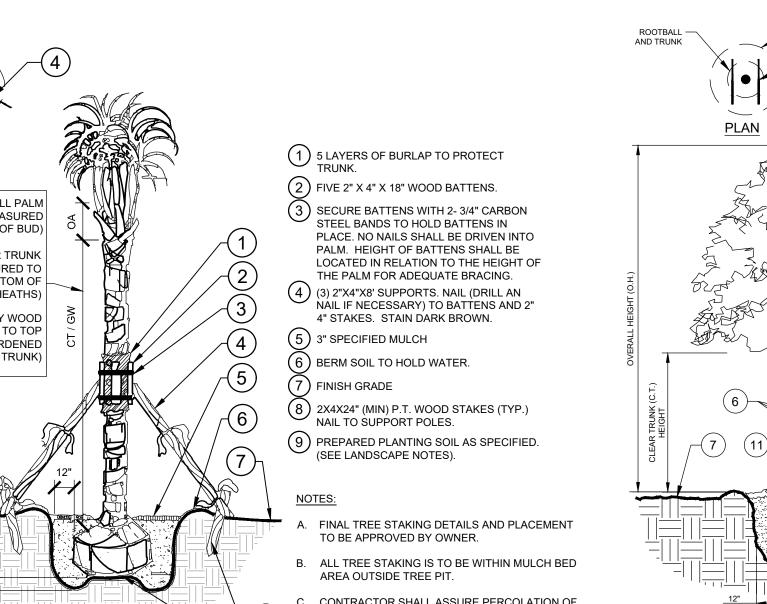

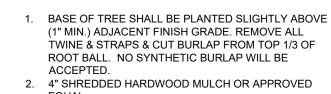

3. DIAMETER OF TREE PIT TO BE TWICE THE DIAMETER OF ROOT BALL-ROUGHEN SIDES OF TREE PIT. 4. 3" HIGH SOIL BERM TO HOLD WATER.

5. TOPSOIL MIX BACKFILL. TREE WRAP. 7. 4" MIN. OF TOPSOIL TO BRING TO FINISHED GRADE

(SEE GRADING PLAN). 8. ROOT BALLS GREATER THAN 24" DIAMETER SHALL BE PLACED ON MOUND OF UNDISTURBED SOIL TO PREVENT SETTLING ROOT BALLS SMALLER THAN 24" IN DIA. MAY SIT ON COMPACTED EARTH. . UNDISTURBED SUBSOIL. 0. PREPARE PLANTING SOIL AS SPECIFIED.

11. Tree Frog® RBK40pt FOR UP TO 4" TREE CALIPER OR Tree Frog® RBK60pt FOR GREATER THAN 4" AND UP TO 6" TREE CALIPER. REFER TO SITEWORK SPECIFICATIONS FOR APPROVED MATERIALS AND INSTALLATION REQUIREMENTS.

A. FINAL TREE STAKING DETAILS AND PLACEMENT TO BE

B. SET TREE AT ORIGINAL DEPTH. REMOVE BURLAP, WIRE AND STRAPS (ANYTHING THAT COULD GIRDLE TREE OR RESTRIC' ROOT GROWTH) ON UPPER 1/3 OF ROOTBALL. SEE LANDSCAPE NOTES FOR THE TYPE OF MULCH MATERIA

D. PRUNE TREE AS DIRECTED BY LANDSCAPE ARCHITECT E. ASSURE PERCOLATION OF ALL PLANTING PITS


MULTI-TRUNK TREE PLANTING

OA =OVERALL PALM HEIGHT (MEASURED TO TOP OF BUD) CT =CLEAR TRUNK (MEASURED TO BOTTOM OF LEAF SHEATHS) GW =GRAY WOOD (MEASURED TO TOP OF HARDENED TRUNK)

11 \ PALM PLANTING

CONTRACTOR SHALL ASSURE PERCOLATION OF ALL PLANTING PITS PRIOR TO INSTALLATION -REFER TO POOR DRAINAGE CONDITION DETAIL

SHEET NUMBER L1.50

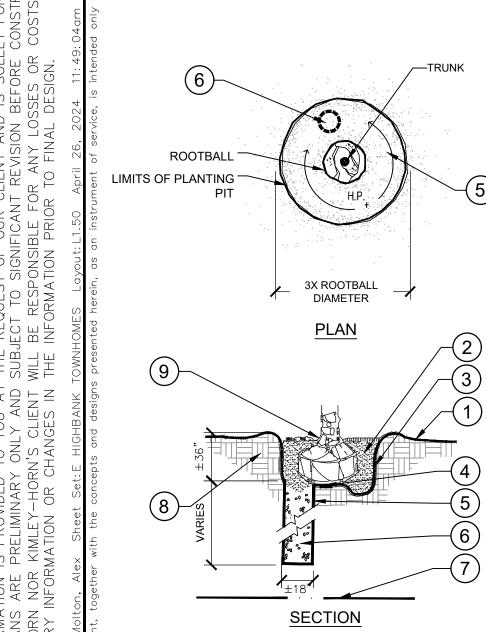

9 \ POOR DRAINAGE CONDITION

 \mid ig) FINISH GRADE (SEE GRADING PLANS). BACKFILL WITH PREPARED PLANTING SOIL MIX AS SPECIFIED. (3) FILTER CLOTH, MIRAFI 500X OR BETTER.

4) SLOPE BOTTOM TO DRAIN. (5) AUGURED HOLE Ø ±18" PENETRATE THROUGH OCCLUDING LAYER TO WATER TABLE OR TO A DEPTH OF 7' TO ASSURE PROPER PERCOLATION. (6) BACKFILL WITH 1/2" - 3/4" GRAVEL TO

REQUIRED DEPTH THROUGH OCCLUDING LAYER TO ASSURE PROPER PERCOLATION. (7) WATER TABLE. (DEPTH VARIES)

8) UNDISTURBED NATIVE SOIL. SET ROOTBALL ON UNDISTURBED STABLE SUBSOIL SO THAT TOP OF ROOT BALL IS " ABOVE FINISHED GRADE.

A. THIS DETAIL SHALL BE IMPLEMENTED WHERE PERCOLATION RATES ARE 2" PER HOUR OR

B. CONTRACTOR TO PERFORM PERCOLATION TEST AS REQUIRED. AND NOTIFY OWNER/LANDSCAPE

C. SEE TYPICAL TREE PLANTING DETAIL THIS SHEET FOR PLANT STAKING.

TREE PROTECTION FENCING

CONNECTION

CORNER

ELEVATION

<u>PLAN</u>

CONNECTION

1) 6'H "PERIMETER PLUS" CONSTRUCTION FENCE BY CONWED PLASTICS OR OWNER'S REPRESENTATIVE APPROVED EQUAL. SUBMIT PRODUCT INFORMATION FOR APPROVAL PRIOR TO INSTALLATION.

2) 8' TALL METAL "T" POSTS OR 2" x 2" X 8' PRESSURE TREATED WOOD POSTS WITH 24" BURIAL BELOW GRADE.

INSTALLATION NOTES:

A. POST SELECTION SHOULD BE BASED ON EXPECTED STRENGTH NEEDS AND THE LENGTH OF TIME FENCE WILL BE IN PLACE. FLEXIBLE FIBERGLASS ROD POSTS ARE RECOMMENDED FOR PARKS, ATHLETIC EVENTS AND CROWD CONTROL INSTALLATIONS. METAL "T" POSTS OR TREATED WOOD POSTS ARE TYPICALLY USED FOR CONSTRUCTION AND OTHER APPLICATIONS.

B. POSTS SHOULD BE DRIVEN INTO THE GROUND TO A DEPTH OF 1/3 OF THE HEIGHT OF THE POST. FOR EXAMPLE, A 6' POST SHOULD BE SET AT LEAST 2' INTO THE GROUND.

C. SPACE POSTS EVERY 6' (MIN.) TO 8' (MAX.).

D. SECURE FENCING TO POST WITH NYLON CABLE TIES (AVAILABLE FROM CONWED PLASTICS). WOOD STRIPS MAY BE ALSO BE USED TO PROVIDE ADDITIONAL SUPPORT AND PROTECTION BETWEEN TIES AND POSTS.

NOTE: IF WIRE TIES ARE USED, AVOID DIRECT CONTACT WITH FENCE. WIRE MAY DAMAGE FENCE OVER TIME.

A. SCOPE OF WORK

- THE WORK CONSISTS OF: FURNISHING ALL LABOR, MATERIALS, EQUIPMENT, TOOLS, TRANSPORTATION, AND ANY OTHER APPURTENANCES NECESSARY FOR THE COMPLETION OF THIS PROJECT AS SHOWN ON THE DRAWINGS, AS INCLUDED IN THE PLANT LIST, AND AS SPECIFIED
- 2. WORK SHALL INCLUDE MAINTENANCE AND WATERING OF ALL CONTRACT PLANTING AREAS UNTIL CERTIFICATION OF ACCEPTANCE BY THE

B. PROTECTION OF EXISTING STRUCTURES

- 1. ALL EXISTING BUILDINGS, WALKS, WALLS, PAVING, PIPING, OTHER SITE CONSTRUCTION ITEMS, AND PLANTING ALREADY COMPLETED OR ESTABLISHED AND DESIGNATED TO REMAIN SHALL BE PROTECTED FROM DAMAGE BY THE CONTRACTOR UNLESS OTHERWISE SPECIFIED. ALL DAMAGE RESULTING FROM NEGLIGENCE SHALL BE REPAIRED OR REPLACED TO THE SATISFACTION OF THE OWNER, AT NO COST TO THE
- 2. THE CONTRACTOR SHALL BE RESPONSIBLE FOR MAINTAINING ALL NECESSARY BMP DEVICES ACCORDING TO ALL REGULATORY AGENCY'S STANDARDS THROUGH THE DURATION OF ALL CONSTRUCTION ACTIVITIES.
- THE CONTRACTOR SHALL SUBMIT A DETAILED PROJECT SPECIFIC WORK ZONE TRAFFIC CONTROL PLAN UNLESS THE WORK REQUIRES NOTHING MORE THAN A DIRECT APPLICATION OF FDOT DESIGN STANDARDS, INDEX 600. IF A DIRECT APPLICATION OF INDEX 600 IS PROPOSED, THE CONTRACTOR SHALL SUBMIT IN WRITING A STATEMENT INDICATING THE STANDARD INDEX AND PAGE NUMBER NO LESS THAN 10 BUSINESS DAYS PRIOR TO START OF CONSTRUCTION. WHEN A DIRECT APPLICATION OF FDOT STANDARD INDEX 600 IS NOT ACCEPTABLE A PROJECT SPECIFIC WORK ZONE TRAFFIC CONTROL PLAN SHALL BE PREPARED BY A FLORIDA PROFESSIONAL ENGINEER WHO HAS SUCCESSFULLY COMPLETED ADVANCED TRAINING IN MAINTENANCE OF TRAFFIC, AS DEFINED BY FDOT FOR APPROVAL BY THE COUNTY ENGINEER'S
- THE CONTRACTOR SHALL BE RESPONSIBLE FOR LOCATING ALL UTILITIES, WHETHER PUBLIC OR PRIVATE, PRIOR TO EXCAVATION. THE INFORMATION AND DATA SHOWN WITH RESPECT TO EXISTING UNDERGROUND FACILITIES AT OR CONTIGUOUS TO THE SITE IS APPROXIMATE AND BASED ON INFORMATION FURNISHED BY THE OWNER OF SUCH UNDERGROUND FACILITIES OR ON PHYSICAL APPURTENANCES OBSERVED IN THE FIELD. THE OWNER AND DESIGN PROFESSIONAL SHALL NOT BE RESPONSIBLE FOR THE ACCURACY AND COMPLETENESS OF ANY SUCH INFORMATION OR DATA. THE CONTRACTOR SHALL HAVE FULL RESPONSIBILITY FOR; REVIEWING AND CHECKING ALL SUCH INFORMATION AND DATA; LOCATING ALL UNDERGROUND FACILITIES DURING CONSTRUCTION; THE SAFETY AND PROTECTION THEREOF; REPAIRING ANY DAMAGE THERETO RESULTING FROM THE WORK. THE COST OF ALL WILL BE CONSIDERED AS HAVING BEEN INCLUDED IN THE CONTRACT PRICE. THE CONTRACTOR SHALL NOTIFY ANY AFFECTED UTILITY COMPANIES OR AGENCIES IN WRITING AT LEAST 48 HOURS PRIOR TO BEGINNING CONSTRUCTION.

C. PROTECTION OF EXISTING PLANT MATERIALS

THE CONTRACTOR SHALL BE RESPONSIBLE FOR ALL UNAUTHORIZED CUTTING OR DAMAGE TO TREES AND SHRUBS EXISTING OR OTHERWISE, CAUSED BY CARELESS EQUIPMENT OPERATION, MATERIAL STOCKPILING, ETC... THIS SHALL INCLUDE COMPACTION BY DRIVING OR PARKING INSIDE THE DRIP-LINE AND SPILLING OIL, GASOLINE, OR OTHER DELETERIOUS MATERIALS WITHIN THE DRIP-LINE. NO MATERIALS SHALL BE BURNED ON SITE. EXISTING TREES KILLED OR DAMAGED SO THAT THEY ARE MISSHAPEN AND/OR UNSIGHTLY SHALL BE REPLACED AT THE COST TO THE CONTRACTOR OF THREE HUNDRED DOLLARS (\$300) PER CALIPER INCH ON AN ESCALATING SCALE WHICH ADDS AN ADDITIONAL TWENTY (20) PERCENT PER INCH OVER FOUR (4) INCHES CALIPER AS FIXED AND AGREED LIQUIDATED DAMAGES. CALIPER SHALL BE MEASURED SIX (6) INCHES ABOVE GROUND LEVEL FOR TREES UP TO AND INCLUDING FOUR (4) INCHES IN CALIPER AND TWELVE (12) INCHES ABOVE GROUND LEVEL FOR TREES OVER FOUR (4) INCHES IN CALIPER.

2. SEE TREE MITIGATION PLAN AND NOTES, IF APPLICABLE

MATERIALS

MATERIAL SAMPLES LISTED BELOW SHALL BE SUBMITTED FOR APPROVAL, ON SITE OR AS DETERMINED BY THE OWNER. UPON APPROVAL, DELIVERY OF MATERIALS MAY COMMENCE.

MATERIAL	SAMPLE SIZE
MULCH	ONE (1) CUBIC FOOT
TOPSOIL MIX	ONE (1) CUBIC FOOT
PLANTS	ONE (1) OF EACH VARIETY (OR TAGGED IN NURSE

PLANT MATERIALS

- a. PLANT SPECIES AND SIZE SHALL CONFORM TO THOSE INDICATED ON THE DRAWINGS. ALL NURSERY STOCK SHALL BE IN ACCORDANCE WITH GRADES AND STANDARDS FOR NURSERY PLANTS, LATEST EDITION, PUBLISHED BY THE FLORIDA DEPARTMENT OF AGRICULTURE AND ONSUMER SERVICES. ALL PLANTS SHALL BE FLORIDA GRADE NO. 1 OR BETTER AS DETERMINED BY THE FLORIDA DIVISION OF PLANT INDUSTRY. ALL PLANTS SHALL BE HEALTHY, VIGOROUS, SOUND, WELL-BRANCHED, AND FREE OF DISEASE AND INSECTS, INSECT EGGS AND LARVAE AND SHALL HAVE ADEQUATE ROOT SYSTEMS. TREES FOR PLANTING IN ROWS SHALL BE UNIFORM IN SIZE AND SHAPE. ALL MATERIALS SHALL BE SUBJECT TO APPROVAL BY THE OWNER. WHERE ANY REQUIREMENTS ARE OMITTED FROM THE PLANT LIST, THE PLANTS FURNISHED SHALL BE NORMAL FOR THE VARIETY. PLANTS SHALL BE PRUNED PRIOR TO DELIVERY ONLY WITH APPROVAL FROM OWNER OR OWNER'S REPRESENTATIVE. NO SUBSTITUTIONS SHALL BE MADE WITHOUT WRITTEN PERMISSION FROM THE OWNER'S REPRESENTATIVE
- b. MEASUREMENTS: THE HEIGHT AND/OR WIDTH OF TREES SHALL BE MEASURED FROM THE GROUND OR ACROSS THE NORMAL SPREAD OF BRANCHES WITH THE PLANTS IN THEIR NORMAL POSITION. THIS MEASUREMENT SHALL NOT INCLUDE THE IMMEDIATE TERMINAL GROWTH PLANTS LARGER IN SIZE THAN THOSE SPECIFIED IN THE PLANT LIST MAY BE USED IF APPROVED BY THE OWNER. IF THE USE OF LARGER PLANTS IS APPROVED, THE BALL OF EARTH OR SPREAD OF ROOTS SHALL BE INCREASED IN PROPORTION TO THE SIZE OF THE PLANT.
- c. INSPECTION: PLANTS SHALL BE SUBJECT TO INSPECTION AND APPROVAL AT THE PLACE OF GROWTH, OR UPON DELIVERY TO THE SITE, AS DETERMINED BY THE OWNER, FOR QUALITY, SIZE, AND VARIETY. SUCH APPROVAL SHALL NOT IMPAIR THE RIGHT OF INSPECTION AND REJECTION AT THE SITE DURING PROGRESS OF THE WORK OR AFTER COMPLETION FOR SIZE AND CONDITION OF ROOT BALLS OR ROOTS, LATENT DEFECTS OR INJURIES. REJECTED PLANTS SHALL BE REMOVED IMMEDIATELY FROM THE SITE. NOTICE REQUESTING INSPECTION SHALL BE SUBMITTED IN WRITING BY THE CONTRACTOR AT LEAST ONE (1) WEEK PRIOR TO ANTICIPATED DATE.

SOIL MIXTURE (PLANTING MEDIUM, PLANTING MIX, TOPSOIL MIX)

- 1. CONTRACTOR SHALL TEST EXISTING SOIL AND AMEND AS NECESSARY IN ACCORDANCE WITH THE GUIDELINES BELOW:
- SOIL MIXTURE (PLANTING MEDIUM FOR PLANT PITS) SHALL CONSIST OF TWO PARTS OF TOPSOIL AND ONE PART SAND, AS DESCRIBED BELOW. CONTRACTOR TO SUBMIT SAMPLES AND PH TESTING RESULTS OF SOIL MIXTURE FOR OWNER'S REPRESENTATIVE APPROVAL PRIOR TO PLANT
- a. TOPSOIL FOR USE IN PREPARING SOIL MIXTURE FOR BACKFILLING PLANT PITS SHALL BE FERTILE, FRIABLE, AND OF A LOAMY CHARACTER; ASONABLY FREE OF SUBSOIL. CLAY LUMPS. BRUSH WEEDS AND OTHER LITTER: FREE OF ROOTS. STUMPS. STONES LARGER THAN 2" IN ANY DIRECTION, AND OTHER EXTRANEOUS OR TOXIC MATTER HARMFUL TO PLANT GROWTH. IT SHALL CONTAIN THREE (3) TO FIVE (5) PERCENT DECOMPOSED ORGANIC MATTER AND HAVE A PH BETWEEN 5.5 AND 7.0.
- b. <u>SAND</u> SHALL BE COARSE, CLEAN, WELL-DRAINING, NATIVE SAND.
- 2. TREES SHALL BE PLANTED IN THE EXISTING NATIVE SOIL ON SITE, UNLESS DETERMINED TO BE UNSUITABLE AT WHICH POINT THE CONTRACTOR SHALL CONTACT OWNER'S REPRESENTATIVE TO DISCUSS ALTERNATE RECOMMENDATION PRIOR TO PLANTING.

WATER NECESSARY FOR PLANTING AND MAINTENANCE SHALL BE OF SATISFACTORY QUALITY TO SUSTAIN ADEQUATE PLANT GROWTH AND SHALL NOT CONTAIN HARMFUL, NATURAL OR MAN-MADE ELEMENTS DETRIMENTAL TO PLANTS. WATER MEETING THE ABOVE STANDARD SHALL BE OBTAINED ON THE SITE FROM THE OWNER, IF AVAILABLE, AND THE CONTRACTOR SHALL BE RESPONSIBLE TO MAKE ARRANGEMENTS FOR ITS USE BY HIS TANKS, HOSES, SPRINKLERS, ETC.... IF SUCH WATER IS NOT AVAILABLE AT THE SITE, THE CONTRACTOR SHALL PROVIDE SATISFACTORY WATER FROM SOURCES OFF THE SITE AT NO ADDITIONAL COST TO THE OWNER.

* WATERING/IRRIGATION RESTRICTIONS MAY APPLY - REFER TO PROPERTY'S JURISDICTIONAL AUTHORITY.

* FERTILIZER RESTRICTIONS MAY APPLY - REFER TO PROPERTY'S JURISDICTIONAL AUTHORITY.

CONTRACTOR SHALL PROVIDE FERTILIZER APPLICATION SCHEDULE TO OWNER, AS APPLICABLE TO SOIL TYPE, PLANT INSTALLATION TYPE, AND SITE'S PROPOSED USE. SUGGESTED FERTILIZER TYPES SHALL BE ORGANIC OR OTHERWISE NATURALLY-DERIVED.

- MULCH MATERIAL SHALL BE MOISTENED AT THE TIME OF APPLICATION TO PREVENT WIND DISPLACEMENT, AND APPLIED AT A DEPTH OF THREE (3) INCHES. CLEAR MULCH FROM EACH PLANT'S CROWN (BASE). MULCH SHALL BE "FLORIMULCH," EUCALYPTUS MULCH, OR SIMILAR SUSTAINABLY HARVESTED MULCH UNLESS SPECIFIED OTHERWISE.
- PROVIDE A THREE (3) INCH MINIMUM LAYER OF SPECIFIED MULCH OVER THE ENTIRE AREA OF EACH SHRUB BED, GROUND COVER, VINE BED, AND TREE PIT (6' MINIMUM) PLANTED UNDER THIS CONTRACT.

DIGGING AND HANDLING

- PROTECT ROOTS OR ROOT BALLS OF PLANTS AT ALL TIMES FROM SUN, DRYING WINDS, WATER AND FREEZING, AS NECESSARY UNTIL PLANTING. PLANT MATERIALS SHALL BE ADEQUATELY PACKED TO PREVENT DAMAGE DURING TRANSIT. TREES TRANSPORTED MORE THAN TEN (10) MILES OR WHICH ARE NOT PLANTED WITHIN THREE (3) DAYS OF DELIVERY TO THE SITE SHALL BE SPRAYED WITH AN ANTITRANSPIRANT PRODUCT ("WILTPRUF" OR EQUAL) TO MINIMIZE TRANSPIRATIONAL WATER LOSS.
- BALLED AND BURLAPPED (B&B), AND FIELD GROWN (FG) PLANTS SHALL BE DUG WITH FIRM, NATURAL BALLS OF SOIL OF SUFFICIENT SIZE TO ENCOMPASS THE FIBROUS AND FEEDING ROOTS OF THE PLANTS. NO PLANTS MOVED WITH A ROOT BALL SHALL BE PLANTED IF THE BALL IS CRACKED OR BROKEN. PLANTS SHALL NOT BE HANDLED BY STEMS.

- PLANTS MARKED "BR" IN THE PLANT LIST SHALL BE DUG WITH BARE ROOTS. CARE SHALL BE EXERCISED THAT THE ROOTS DO NOT DRY OUT DURING TRANSPORTATION AND PRIOR TO PLANTING.
- PROTECTION OF PALMS: ONLY A MINIMUM OF FRONDS SHALL BE REMOVED FROM THE CROWN OF THE PALM TREES TO FACILITATE MOVING AND HANDLING. CLEAR TRUNK (CT) SHALL BE AS SPECIFIED AFTER THE MINIMUM OF FRONDS HAVE BEEN REMOVED. ALL PALMS SHALL BE BRACED
- EXCAVATION OF TREE PITS SHALL BE PERFORMED USING EXTREME CARE TO AVOID DAMAGE TO SURFACE AND SUBSURFACE ELEMENTS SUCH AS UTILITIES OR HARDSCAPE ELEMENTS, FOOTERS AND PREPARED SUB-BASES.

- ALL CONTAINER GROWN MATERIAL SHALL BE HEALTHY, VIGOROUS, WELL-ROOTED PLANTS ESTABLISHED IN THE CONTAINER IN WHICH THEY ARE SOLD. THE PLANTS SHALL HAVE TOPS WHICH ARE OF GOOD QUALITY AND ARE IN A HEALTHY GROWING CONDITION.
- AN ESTABLISHED CONTAINER GROWN PLANT SHALL BE TRANSPLANTED INTO A CONTAINER AND GROWN IN THAT CONTAINER SUFFICIENTLY LONG ENOUGH FOR THE NEW FIBROUS ROOTS TO HAVE DEVELOPED SO THAT THE ROOT MASS WILL RETAIN ITS SHAPE AND HOLD TOGETHER WHEN REMOVED FROM THE CONTAINER. CONTAINER GROWN STOCK SHALL NOT BE HANDLED BY THEIR STEMS.
- 3. ROOT BOUND PLANTS ARE NOT ACCEPTABLE AND WILL BE REJECTED.
- 4. RPG= "ROOTS PLUS GROWER" CONTAINER PRODUCTS SHALL BE USED WHERE SPECIFIED.

K. COLLECTED STOCK

WHEN THE USE OF COLLECTED STOCK IS PERMITTED AS INDICATED BY THE OWNER OR OWNER'S REPRESENTATIVE, THE MINIMUM SIZES OF ROOTBALLS SHALL BE EQUAL TO THAT SPECIFIED FOR THE NEXT LARGER SIZE OF NURSERY GROWN STOCK OF THE SAME VARIETY.

PLANTS COLLECTED FROM WILD OR NATIVE STANDS SHALL BE CONSIDERED NURSERY GROWN WHEN THEY HAVE BEEN SUCCESSEULLY RE-ESTABLISHED IN A NURSERY ROW AND GROWN UNDER REGULAR NURSERY CULTURAL PRACTICES FOR A MINIMUM OF TWO (2) GROWING SEASONS AND HAVE ATTAINED ADEQUATE ROOT AND TOP GROWTH TO INDICATE FULL RECOVERY FROM TRANSPLANTING INTO THE NURSERY ROW.

MATERIALS LIST

QUANTITIES NECESSARY TO COMPLETE THE WORK ON THE DRAWINGS SHALL BE FURNISHED BY THE CONTRACTOR. QUANTITY ESTIMATES HAVE BEEN MADE CAREFULLY, BUT THE LANDSCAPE ARCHITECT OR OWNER ASSUMES NO LIABILITY FOR OMISSIONS OR ERRORS. SHOULD A DISCREPANCY OCCUR BETWEEN THE PLANS AND THE PLANT LIST QUANTITY, THE OWNER'S REPRESENTATIVE SHALL BE NOTIFIED FOR CLARIFICATION PRIOR TO BIDDING OR INSTALLATION. ALL DIMENSIONS AND/OR SIZES SPECIFIED SHALL BE THE MINIMUM ACCEPTABLE SIZE.

FINE GRADING UNDER THIS CONTRACT SHALL CONSIST OF FINAL FINISHED GRADING OF LAWN AND PLANTING AREAS THAT HAVE BEEN ROUGH GRADED BY OTHERS. BERMING AS SHOWN ON THE DRAWINGS SHALL BE THE RESPONSIBILITY OF THE CONTRACTOR, UNLESS OTHERWISE

THE CONTRACTOR SHALL FINE GRADE THE LAWN AND PLANTING AREAS TO BRING THE ROUGH GRADE UP TO FINAL FINISHED GRADE ALLOWING

- FOR THICKNESS OF SOD AND/OR MULCH DEPTH. CONTRACTOR SHALL FINE GRADE BY HAND AND/OR WITH ALL EQUIPMENT NECESSARY INCLUDING A GRADING TRACTOR WITH FRONT-END LOADER FOR TRANSPORTING SOIL WITHIN THE SITE. ALL PLANTING AREAS SHALL BE GRADED AND MAINTAINED FOR POSITIVE DRAINAGE TO SURFACE/SUBSURFACE STORM DRAIN SYSTEMS. AREAS
- ADJACENT TO BUILDINGS SHALL SLOPE AWAY FROM THE BUILDINGS. REFER TO CIVIL ENGINEER'S PLANS FOR FINAL GRADES, IF APPLICABLE.

- CLEANING UP BEFORE COMMENCING WORK: THE CONTRACTOR SHALL CLEAN WORK AND SURROUNDING AREAS OF ALL RUBBISH OR OBJECTIONABLE MATTER DAILY. ALL MORTAR, CEMENT, AND TOXIC MATERIAL SHALL BE REMOVED FROM THE SURFACE OF ALL PLANT BEDS. THESE MATERIALS SHALL NOT BE MIXED WITH THE SOIL. SHOULD THE CONTRACTOR FIND SUCH SOIL CONDITIONS BENEATH THE SOIL WHICH WILL IN ANY WAY ADVERSELY AFFECT THE PLANT GROWTH, HE SHALL IMMEDIATELY CALL IT TO THE ATTENTION OF THE OWNER'S REPRESENTATIVE. FAILURE TO DO SO BEFORE PLANTING SHALL MAKE THE CORRECTIVE MEASURES THE RESPONSIBILITY OF THE CONTRACTOR.
- VERIFY LOCATIONS OF ALL UTILITIES, CONDUITS, SUPPLY LINES AND CABLES, INCLUDING BUT NOT LIMITED TO: ELECTRIC, GAS (LINES AND TANKS), WATER, SANITARY SEWER, STORMWATER SYSTEMS, CABLE, AND TELEPHONE. PROPERLY MAINTAIN AND PROTECT EXISTING UTILITIES. CALL SUNSHINE STATE ONE CALL OF FLORIDA, INC. (811) TO LOCATE UTILITIES AT LEAST 48 HOURS PRIOR TO CONSTRUCTION.
- SUBGRADE EXCAVATION: CONTRACTOR IS RESPONSIBLE TO REMOVE ALL EXISTING AND IMPORTED LIMEROCK AND LIMEROCK SUB-BASE FROM ALL LANDSCAPE PLANTING AREAS TO A MINIMUM DEPTH OF 36" OR TO NATIVE SOIL. CONTRACTOR IS RESPONSIBLE TO BACKFILL THESE PLANTING AREAS TO ROUGH FINISHED GRADE WITH CLEAN TOPSOIL FROM AN ON-SITE SOURCE OR AN IMPORTED SOURCE. IF LIMEROCK OR OTHER ADVERSE CONDITIONS OCCUR IN PLANTED AREAS AFTER 36" DEEP EXCAVATION BY THE CONTRACTOR, AND POSITIVE DRAINAGE CAN NOT BE ACHIEVED, CONTRACTOR SHALL UTILIZE POOR DRAINAGE CONDITION PLANTING DETAIL.
- FURNISH NURSERY'S CERTIFICATE OF COMPLIANCE WITH ALL REQUIREMENTS AS SPECIFIED HEREIN. INSPECT AND SELECT PLANT MATERIALS BEFORE PLANTS ARE DUG AT NURSERY OR GROWING SITE.
- COMPLY WITH APPLICABLE FEDERAL, STATE, COUNTY, AND LOCAL REGULATIONS GOVERNING LANDSCAPE MATERIALS AND WORK. CONFORM TO ACCEPTED HORTICULTURAL PRACTICES AS USED IN THE TRADE. UPON ARRIVAL AT THE SITE, PLANTS SHALL BE THOROUGHLY WATERED AND PROPERLY MAINTAINED UNTIL PLANTED. PLANTS STORED ONSITE SHALL NOT REMAIN UNPLANTED OR APPROPRIATELY HEALED IN FOR A PERIOD EXCEEDING TWENTY-FOUR (24) HOURS. AT ALL TIMES WORKMANLIKE METHODS CUSTOMARY IN GOOD HORTICULTURAL PRACTICES
- THE WORK SHALL BE COORDINATED WITH OTHER TRADES TO PREVENT CONFLICTS. COORDINATE PLANTING WITH IRRIGATION WORK TO ASSURE AVAILABILITY OF WATER AND PROPER LOCATION OF IRRIGATION APPURTENANCES AND PLANTS.
- ALL PLANTING PITS SHALL BE EXCAVATED TO SIZE AND DEPTH IN ACCORDANCE WITH THE USA STANDARD FOR NURSERY STOCK 260.1, UNLESS SHOWN OTHERWISE ON THE DRAWINGS, AND BACK FILLED WITH THE PREPARED PLANTING SOIL MIXTURE AS SPECIFIED IN SECTION E. TEST ALL TREE PITS WITH WATER BEFORE PLANTING TO ASSURE PROPER DRAINAGE PERCOLATION IS AVAILABLE. NO ALLOWANCE WILL BE MADE FOR LOST PLANTS DUE TO IMPROPER DRAINAGE. IF POOR DRAINAGE EXISTS, UTILIZE "POOR DRAINAGE CONDITION" PLANTING DETAIL. TREES SHALL BE SET PLUMB AND HELD IN POSITION UNTIL THE PLANTING MIXTURE HAS BEEN FLUSHED INTO PLACE WITH A SLOW, FULL HOSE STREAM. ALL PLANTING SHALL BE PERFORMED BY PERSONNEL FAMILIAR WITH PLANTING PROCEDURES AND UNDER THE SUPERVISION OF A QUALIFIED LANDSCAPE FOREMAN. PROPER "JETTING IN" SHALL BE ASSURED TO ELIMINATE AIR POCKETS AROUND THE ROOTS. "JET STICK" OR EQUAL IS
- 8. TAKE ALL NECESSARY PRECAUTIONS TO AVOID DAMAGE TO BUILDINGS AND BUILDING STRUCTURES WHILE INSTALLING TREES.
- 9. SOIL MIXTURE SHALL BE AS SPECIFIED IN SECTION E OF THESE SPECIFICATIONS.
- 10. TREES AND SHRUBS SHALL BE SET STRAIGHT AT AN ELEVATION THAT, AFTER SETTLEMENT, THE PLANT CROWN WILL STAND ONE (1) TO TWO (2) INCHES ABOVE GRADE. EACH PLANT SHALL BE SET IN THE CENTER OF THE PIT. PLANTING SOIL MIXTURE SHALL BE BACK FILLED, THOROUGHLY TAMPED AROUND THE BALL, AND SETTLED BY WATER (AFTER TAMPING).
- 11. AMEND PINE AND OAK PLANT PITS WITH ECTOMYCORRHIZAL SOIL APPLICATION PER MANUFACTURER'S RECOMMENDATION. ALL OTHER PLANT PITS SHALL BE AMENDED WITH ENDOMYCORRHIZAL SOIL APPLICATION PER MANUFACTURER'S RECOMMENDATION. PROVIDE PRODUCT
- 12. FILL HOLE WITH SOIL MIXTURE, MAKING CERTAIN ALL SOIL IS SATURATED. TO DO THIS, FILL HOLE WITH WATER AND ALLOW TO SOAK MINIMUM TWENTY (20) MINUTES, STIRRING IF NECESSARY TO GET SOIL THOROUGHLY WET. PACK LIGHTLY WITH FEET, ADD MORE WET SOIL MIXTURE. DO NOT COVER TOP OF BALL WITH SOIL MIXTURE. ALL BURLAP, ROPE, WIRES, BASKETS, ETC.., SHALL BE REMOVED FROM THE SIDES AND TOPS OF BALLS, BUT NO BURLAP SHALL BE PULLED FROM UNDERNEATH.
- 13. TREES SHALL BE PRUNED, AT THE DIRECTION OF THE OWNER OR OWNER'S REPRESENTATIVE, TO PRESERVE THE NATURAL CHARACTER OF THE PLANT. ALL SOFT WOOD OR SUCKER GROWTH AND ALL BROKEN OR BADLY DAMAGED BRANCHES SHALL BE REMOVED WITH A CLEAN CUT. ALL PRUNING TO BE PERFORMED BY CERTIFIED ARBORIST, IN ACCORDANCE WITH ANSI A-300.
- 14. SHRUBS AND GROUND COVER PLANTS SHALL BE EVENLY SPACED IN ACCORDANCE WITH THE DRAWINGS AND AS INDICATED ON THE PLANT LIST. MATERIALS INSTALLED SHALL MEET MINIMUM SPECIMEN REQUIREMENTS OR QUANTITIES SHOW ON PLANS, WHICHEVER IS GREATER. CULTIVATE ALL PLANTING AREAS TO A MINIMUM DEPTH OF 6", REMOVE AND DISPOSE ALL DEBRIS. MIX TOP 4" THE PLANTING SOIL MIXTURE AS SPECIFIED IN SECTION E. THOROUGHLY WATER ALL PLANTS AFTER INSTALLATION.
- 15. TREE GUYING AND BRACING SHALL BE INSTALLED BY THE CONTRACTOR IN ACCORDANCE WITH THE PLANS TO INSURE STABILITY AND MAINTAIN TREES IN AN UPRIGHT POSITION. IF THE CONTRACTOR AND OWNER DECIDE TO WAIVE THE TREE GUYING AND BRACING, THE OWNER SHALL NOTIFY THE PROJECT LANDSCAPE ARCHITECT IN WRITING AND AGREE TO INDEMNIFY AND HOLD HARMLESS THE PROJECT LANDSCAPE ARCHITECT IN THE EVENT UNSUPPORTED TREES PLANTED UNDER THIS CONTRACT FALL AND DAMAGE PERSON OR PROPERTY.
- 16. ALL PLANT BEDS SHALL BE KEPT FREE OF NOXIOUS WEEDS UNTIL FINAL ACCEPTANCE OF WORK. IF DIRECTED BY THE OWNER, "ROUND-UP" SHALL BE APPLIED FOR WEED CONTROL BY QUALIFIED PERSONNEL TO ALL PLANTING AREAS IN SPOT APPLICATIONS PER MANUFACTURER'S PRECAUTIONS AND SPECIFICATIONS. PRIOR TO FINAL INSPECTION, TREAT ALL PLANTING BEDS WITH AN APPROVED PRE-EMERGENT HERBICIDE AT AN APPLICATION RATE RECOMMENDED BY THE MANUFACTURER. (AS ALLOWED BY JURISDICTIONAL AUTHORITY)

- THE WORK CONSISTS OF LAWN BED PREPARATION, SOIL PREPARATION, AND SODDING COMPLETE, IN STRICT ACCORDANCE WITH THE SPECIFICATIONS AND THE APPLICABLE DRAWINGS TO PRODUCE A TURF GRASS LAWN ACCEPTABLE TO THE OWNER.
- ALL AREAS THAT ARE TO BE SODDED SHALL BE CLEARED OF ANY ROUGH GRASS, WEEDS, AND DEBRIS BY MEANS OF A SOD CUTTER TO A DEPTH OF THREE (3) INCHES, AND THE GROUND BROUGHT TO AN EVEN GRADE. THE ENTIRE SURFACE SHALL BE ROLLED WITH A ROLLER WEIGHING NOT MORE THAN ONE-HUNDRED (100) POUNDS PER FOOT OF WIDTH. DURING THE ROLLING, ALL DEPRESSIONS CAUSED BY SETTLEMENT SHALL BE FILLED WITH ADDITIONAL SOIL, AND THE SURFACE SHALL BE REGRADED AND ROLLED UNTIL PRESENTING A SMOOTH AND EVEN FINISH TO THE

3. PREPARE LOOSE BED FOUR (4) INCHES DEEP. HAND RAKE UNTIL ALL BUMPS AND DEPRESSIONS ARE REMOVED. WET PREPARED AREA

- a. THE CONTRACTOR SHALL SOD ALL AREAS THAT ARE NOT PAVED OR PLANTED AS DESIGNATED ON THE DRAWINGS WITHIN THE CONTRACT
- b. THE SOD SHALL BE CERTIFIED TO MEET FLORIDA STATE PLANT BOARD SPECIFICATIONS, ABSOLUTELY TRUE TO VARIETAL TYPE, AND FREE FROM WEEDS, FUNGUS, INSECTS AND DISEASE OF ANY KIND.
- c. SOD PANELS SHALL BE LAID TIGHTLY TOGETHER SO AS TO MAKE A SOLID SODDED LAWN AREA. SOD SHALL BE LAID UNIFORMLY AGAINST THE EDGES OF ALL CURBS AND OTHER HARDSCAPE ELEMENTS, PAVED AND PLANTED AREAS. ADJACENT TO BUILDINGS, A 24 INCH STONE MULCH STRIP SHALL BE PROVIDED. IMMEDIATELY FOLLOWING SOD LAYING, THE LAWN AREAS SHALL BE ROLLED WITH A LAWN ROLLER CUSTOMARILY USED FOR SUCH PURPOSES, AND THEN THOROUGHLY IRRIGATED. IF, IN THE OPINION OF THE OWNER, TOP-DRESSING IS NECESSARY AFTER ROLLING TO FILL THE VOIDS BETWEEN THE SOD PANELS AND TO EVEN OUT INCONSISTENCIES IN THE SOD, CLEAN SAND, AS APPROVED BY THE OWNER'S REPRESENTATIVE, SHALL BE UNIFORMLY SPREAD OVER THE ENTIRE SURFACE OF THE SOD AND THOROUGHLY WATERED IN. FERTILIZE
- DURING DELIVERY, PRIOR TO, AND DURING THE PLANTING OF THE LAWN AREAS, THE SOD PANELS SHALL AT ALL TIMES BE PROTECTED FROM EXCESSIVE DRYING AND UNNECESSARY EXPOSURE OF THE ROOTS TO THE SUN. ALL SOD SHALL BE STACKED SO AS NOT TO BE DAMAGED BY SWEATING OR EXCESSIVE HEAT AND MOISTURE.

- a. WITHIN THE CONTRACT LIMITS, THE CONTRACTOR SHALL PRODUCE A DENSE, WELL ESTABLISHED LAWN. THE CONTRACTOR SHALL BE RESPONSIBLE FOR THE REPAIR AND RE-SODDING OF ALL ERODED, SUNKEN OR BARE SPOTS (LARGER THAN 12"X12") UNTIL CERTIFICATION OF ACCEPTANCE BY THE OWNER'S REPRESENTATIVE. REPAIRED SODDING SHALL BE ACCOMPLISHED AS IN THE ORIGINAL WORK (INCLUDING REGRADING IF NECESSARY).
- TO AND UPON ACCEPTANCE, CONTRACTOR TO PROVIDE WATERING/IRRIGATION SCHEDULE TO OWNER. OBSERVE ALL APPLICABLE WATERING RESTRICTIONS AS SET FORTH BY THE PROPERTY'S JURISDICTIONAL AUTHORITY.

UPON COMPLETION OF ALL PLANTING WORK AND BEFORE FINAL ACCEPTANCE, THE CONTRACTOR SHALL REMOVE ALL MATERIAL, EQUIPMENT, AND DEBRIS RESULTING FROM HIS WORK. ALL PAVED AREAS SHALL BE CLEANED AND THE SITE LEFT IN A NEAT AND ACCEPTABLE CONDITION AS APPROVED BY THE OWNER'S REPRESENTATIVE.

R. PLANT MATERIAL MAINTENANCE

ALL PLANTS AND PLANTING INCLUDED UNDER THIS CONTRACT SHALL BE MAINTAINED BY WATERING, CULTIVATING, SPRAYING, AND ALL OTHER OPERATIONS (SUCH AS RE-STAKING OR REPAIRING GUY SUPPORTS) NECESSARY TO INSURE A HEALTHY PLANT CONDITION BY THE CONTRACTOR UNTIL CERTIFICATION OF ACCEPTANCE BY THE OWNER'S REPRESENTATIVE.

FINAL INSPECTION AND ACCEPTANCE OF WORK

FINAL INSPECTION AT THE END OF THE WARRANTY PERIOD SHALL BE ON PLANTING, CONSTRUCTION AND ALL OTHER INCIDENTAL WORK PERTAINING TO THIS CONTRACT. ANY REPLACEMENT AT THIS TIME SHALL BE SUBJECT TO THE SAME ONE (1) YEAR WARRANTY (OR AS SPECIFIED BY THE LANDSCAPE ARCHITECT OR OWNER IN WRITING) BEGINNING WITH THE TIME OF REPLACEMENT AND ENDING WITH THE SAME INSPECTION AND ACCEPTANCE HEREIN DESCRIBED.

- THE LIFE AND SATISFACTORY CONDITION OF ALL PLANT MATERIAL INSTALLED (INCLUDING SOD) BY THE LANDSCAPE CONTRACTOR SHALL BE WARRANTED BY THE CONTRACTOR FOR A MINIMUM OF ONE (1) CALENDAR YEAR COMMENCING AT THE TIME OF CERTIFICATION OF ACCEPTANCE BY THE OWNER'S REPRESENTATIVE.
- ANY PLANT NOT FOUND IN A HEALTHY GROWING CONDITION AT THE END OF THE WARRANTY PERIOD SHALL BE REMOVED FROM THE SITE AND REPLACED AS SOON AS WEATHER CONDITIONS PERMIT. ALL REPLACEMENTS SHALL BE PLANTS OF THE SAME KIND AND SIZE AS SPECIFIED IN THE PLANT LIST. THEY SHALL BE FURNISHED PLANTED AND MULCHED AS SPECIFIED AT NO ADDITIONAL COST TO THE OWNER.
- IN THE EVENT THE OWNER DOES NOT CONTRACT WITH THE CONTRACTOR FOR LANDSCAPE AND IRRIGATION MAINTENANCE, THE CONTRACTOR SHOULD VISIT THE PROJECT SITE PERIODICALLY DURING THE ONE (1) YEAR WARRANTY PERIOD TO EVALUATE MAINTENANCE PROCEDURES BEING PERFORMED BY THE OWNER. CONTRACTOR SHALL NOTIFY THE OWNER IN WRITING OF MAINTENANCE PROCEDURES OR CONDITIONS WHICH THREATEN VIGOROUS AND HEALTHY PLANT GROWTH. SITE VISITS SHALL BE CONDUCTED A MINIMUM OF ONCE PER MONTH FOR A

- LIMITS. UNLESS SPECIFICALLY NOTED OTHERWISE.
- INSTALLED SOD AS ALLOWED BY PROPERTY'S JURISDICTIONAL AUTHORITY.


LAWN MAINTENANCE

b. CONTRACTOR RESPONSIBLE FOR ESTABLISHING AND MAINTAINING SOD/LAWN UNTIL ACCEPTANCE BY THE OWNER'S REPRESENTATIVE. PRIOR

PERIOD OF TWELVE (12) MONTHS FROM THE DATE OF ACCEPTANCE.

TYPICAL LANDSCAPE SPECIFICATIONS (FLORIDA)

SHEET NUMBER

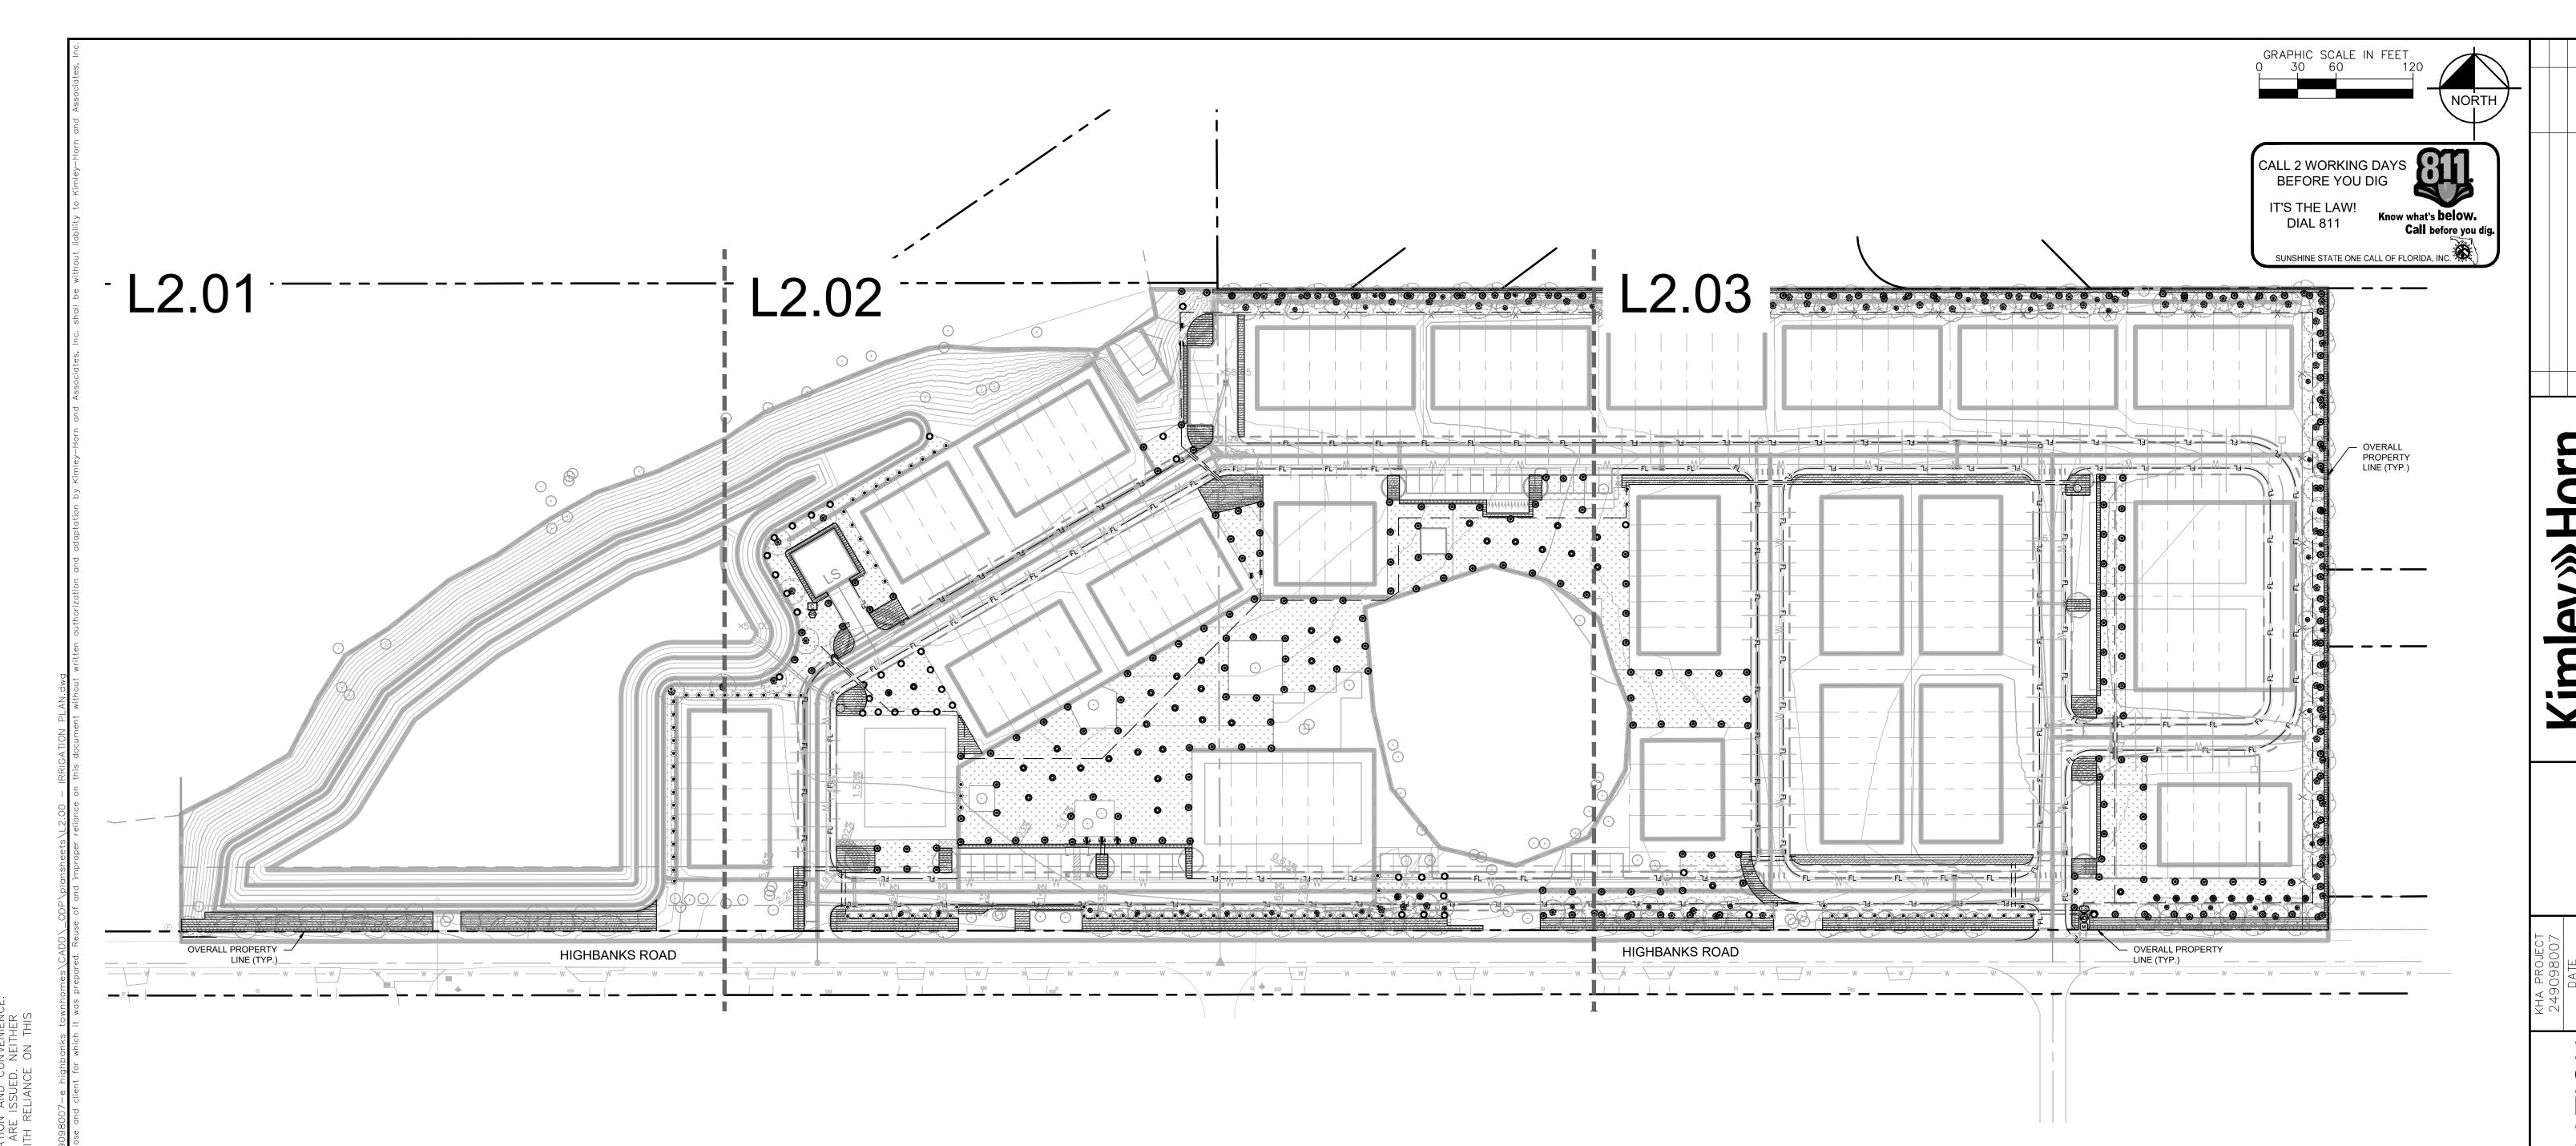

IRRIGATION NOTES

- 1. CONTRACTOR SHALL VERIFY ALL DIMENSIONS, ELEVATIONS, EQUIPMENT QUANTITIES, ETC. PRIOR TO BEGINNING WORK.
- 2. CONTRACTOR SHALL NOTIFY LANDSCAPE ARCHITECT OF ANY DISCREPANCIES IN PLANS OR SPECIFICATIONS PRIOR TO BEGINNING OR
- 3. THE CONTRACTOR SHALL MAKE NO SUBSTITUTIONS, DELETIONS, OR ADDITIONS TO THIS PLAN WITHOUT APPROVAL OF THE LANDSCAPE
- 4. ALL CONSTRUCTION SHALL CONFORM TO CITY, COUNTY, STATE, AND FEDERAL REQUIREMENTS. IT SHALL BE THE RESPONSIBILITY OF THE IRRIGATION CONTRACTOR TO ENSURE THAT ALL IRRIGATION EQUIPMENT MEETS GOVERNMENT REGULATIONS. CONTRACTOR SHALL ALSO BE RESPONSIBLE FOR OBTAINING ANY NECESSARY PERMITS OR APPROVALS.
- 5. THIS PLAN IS SCHEMATIC AND DUE TO THE NATURE OF CONSTRUCTION SLIGHT FIELD MODIFICATIONS MAY BE NECESSARY TO IMPLEMENT
- 6. CONTRACTOR TO VERIFY ACTUAL AVAILABLE WATER PRESSURE BEFORE BEGINNING INSTALLATION. CONTRACTOR SHALL NOTIFY
- LANDSCAPE ARCHITECT IF AVAILABLE WATER PRESSURE WILL NOT ALLOW SYSTEM MODIFICATION TO BE POSSIBLE.
- 7. IRRIGATION SYSTEMS CONNECTED TO REUSE WATER SUPPLY, SHALL HAVE A BACKFLOW PREVENTER INSTALLED. 8. WHERE APPLICABLE IRRIGATION HEADS ARE TO BE ADJUSTED FOR COMPLETE COVERAGE WITH MINIMUM OVER SPRAY BEYOND
- 9. EXISTING TREES TO REMAIN ARE TO BE PROTECTED FROM DAMAGE. DO NOT TRENCH OR EXCAVATE WITHIN THE CRITICAL ROOT ZONE OF

10. ALL IRRIGATION SLEEVING TO BE THE RESPONSIBILITY OF THE IRRIGATION CONTRACTOR. ELECTRICAL WIRES FOR IRRIGATION VALVES AND

- IRRIGATION LINES ARE TO BE PLACED IN SEPARATE SLEEVES.
- 11. IRRIGATION CONTRACTOR SHALL REVIEW WINTERIZATION PROCEDURES FOR IRRIGATION SYSTEM WITH OWNER'S REPRESENTATIVE. 12. ALL PLANT MATERIAL IN TREE HOLDING AREAS SHALL BE MANUALLY WATERED/IRRIGATED TO KEEP MOIST UNTIL PLANTED.
- 13. CONTRACTOR TO PROVIDE PERMANENT BENCH-MARKS ON ALL CURB LINES AT RELATED SLEEVE LOCATIONS (TYP).
- 14. THE IRRIGATION SYSTEM SHALL BE DESIGNED AND INSTALLED TO MINIMIZE ROOT DISTURBANCE IN EXISTING TREES.
- 15. IRRIGATION SPRAYS AND ROTORS ARE NOT COMBINED ON THE SAME CONTROL VALVE CIRCUIT LANDSCAPE BEDS AND TURF ON
- 16. MATCH PRECIPITATION RATES WITH ANY HEADS THAT ARE REPLACED.

IRRIGATION SCHEDULE

IRRIGATION	SCHEDULE				
SYMBOL	MANUFACTURER/MODEL/DESCRIPTION	<u>QTY</u>	<u>PSI</u>		RAIN BIRD
LCS SST RCS	RAIN BIRD R-VAN-STRIP RD-06-SAM-P45-NP TURF ROTARY, 8FT14FT AND HAND ADJUSTABLE MULTI-STREAM ROTARY W/ RD1800 TURF SPRAY BODY ON 6IN. POP-UP, WITH CHECK VALVE AND 45 PSI IN-STEM PRESSURE REGULATOR. 1/2IN. NPT FEMALE THREADED INLET. W/ NON-POTABLE PURPLE CAP.	10	30	(FS)	1-1/2IN. FL RANGE 5.0 SIZE. RAIN LXME2(P) OFFSET. II WATER MI
14 ADJ 14 F	RAIN BIRD R-VAN14 RD-06-SAM-P45-NP TURF ROTARY, 8FT14FT. 45-270 DEGREES AND 360 DEGREES. HAND ADJUSTABLE MULTI-STREAM ROTARY W/RD1800 TURF SPRAY BODY ON 6IN. POP-UP, WITH CHECK VALVE AND 45 PSI IN-STEM PRESSURE REGULATOR. 1/2IN. NPT FEMALE THREADED INLET. W/ NON-POTABLE PURPLE CAP.	104	30	— — — =====	— IRRIGATIO
18 ADJ 18 F	RAIN BIRD R-VAN18 RD-06-SAM-P45-NP TURF ROTARY, 13FT18FT. 45-270 DEGREES AND 360 DEGREES. HAND ADJUSTABLE MULTI-STREAM ROTARY W/RD1800 TURF SPRAY BODY ON 6IN. POP-UP, WITH CHECK VALVE AND 45 PSI IN-STEM PRESSURE REGULATOR. 1/2IN. NPT FEMALE THREADED INLET. W/ NON-POTABLE PURPLE CAP.	49	30		PIPE SLEE
24 ADJ 24 F	RAIN BIRD R-VAN24 RD-06-SAM-P45-NP TURF ROTARY, 17FT24FT. 45-270 DEGREES AND 360 DEGREES. HAND ADJUSTABLE MULTI-STREAM ROTARY W/RD1800 TURF SPRAY BODY ON 6IN. POP-UP, WITH CHECK VALVE AND 45 PSI IN-STEM PRESSURE REGULATOR. 1/2IN. NPT FEMALE THREADED INLET. W/ NON-POTABLE PURPLE CAP.	284	30	FLOW TOTALS Area for Dripline: Drip Ring: Turf Rotary: Total:	482.2 81.6 465.6 1,029 GPM
<u>SYMBOL</u>	MANUFACTURER/MODEL/DESCRIPTION	QTY			
©	RAIN BIRD XFD-09-12-NP DRIP RING	96			
•	RAIN BIRD XFD-09-12-NP DRIP RING (ORNAMENTAL) AREA TO RECEIVE DRIPLINE	49		NECESSARY MODI INTENT OF THESE	RACTOR IS RESPONSIB FICATIONS REQUIRED ⁻ PLANS PRIOR TO SUBM FLINE THE OVERALL LA
	RAIN BIRD XFD-09-12-NP XFD ON-SURFACE PRESSURE COMPENSATING LANDSCAPE DRIPLINE. 0.9 GPH EMITTERS AT 12" O.C. DRIPLINE LATERALS SPACED AT 12" APART, WITH EMITTERS OFFSET FOR TRIANGULAR PATTERN. UV RESISTANT. SPECIFY XF INSERT FITTINGS.	32,144 L.F.		IT SHALL BE THE R THE SYSTEM ACCO CONTRACTOR SHA BUT NOT LIMITED	ESPONSIBILITY OF THE DRDINGLY BASED ON F ALL BE RESPONSIBLE F TO AVAILABLE FLOW, A EMBLY, CAPACITY OF T
SYMBOL	MANUFACTURER/MODEL/DESCRIPTION	QTY			·
(C)	RAIN BIRD PESBR-PRS-D 1-1/2" 1IN., 1-1/2IN., 2IN. DURABLE CHLORINE-RESISTANT MASTER VALVES FOR RECLAIMED WATER APPLICATIONS. WITH SCRUBBER MECHANISM TECHNOLOGY, PURPLE FLOW CONTROL HANDLE, AND PRESSURE REGULATOR MODULE.	1			
С	RAIN BIRD ESPLXME2 W/ (2) ESPLXMSM12 36 STATION, TRADITIONALLY-WIRED, COMMERCIAL CONTROLLER. (1)	1			

ESPLXME2 12-STATION, INDOOR/OUTDOOR, PLASTIC WALL-MOUNT ENCLOSURE W/ (2) ESPLXMSM12 - 12-STATION EXPANSION MODULES.

RAIN SENSOR, WITH METAL LATCHING BRACKET, EXTENSION WIRE.


RAIN BIRD RSD-BEX


FLOW SENSOR, PLASTIC PVC MODEL. SUGGESTED OPERATING 5.0 GPM TO 100.0 GPM. SIZE FOR FLOW NOT ACCORDING TO PIPE 1 AIN BIRD COMPATIBLE CONTROLLERS: ESP-LXIVM(P) | LXD | P) | ME3, OR CONTROLLERS ACCEPTING CUSTOM K-FACTOR AND . INSTALL IN RAIN BIRD VALVE BOX. R METER 1-1/2"

TION MAINLINE: PVC SCHEDULE 40 3,339 L.F. LEEVE: PVC SCHEDULE 40 - LATERAL SLEEVE 174.8 L.F. LEEVE: PVC SCHEDULE 40 - MAINLINE SLEEVE

SIBLE FOR PERFORMING ALL ED TO MEET THE SCHEMATIC BMITTING PROPOSAL. LAYOUT THE SYSTEM AND HE CONTRACTOR TO ZONE I FLOW AND PRESSURE AVAILABLE. FOR VERIFYING THE FOLLOWING , AVAILABLE PRESSURE, THE SYSTEM.

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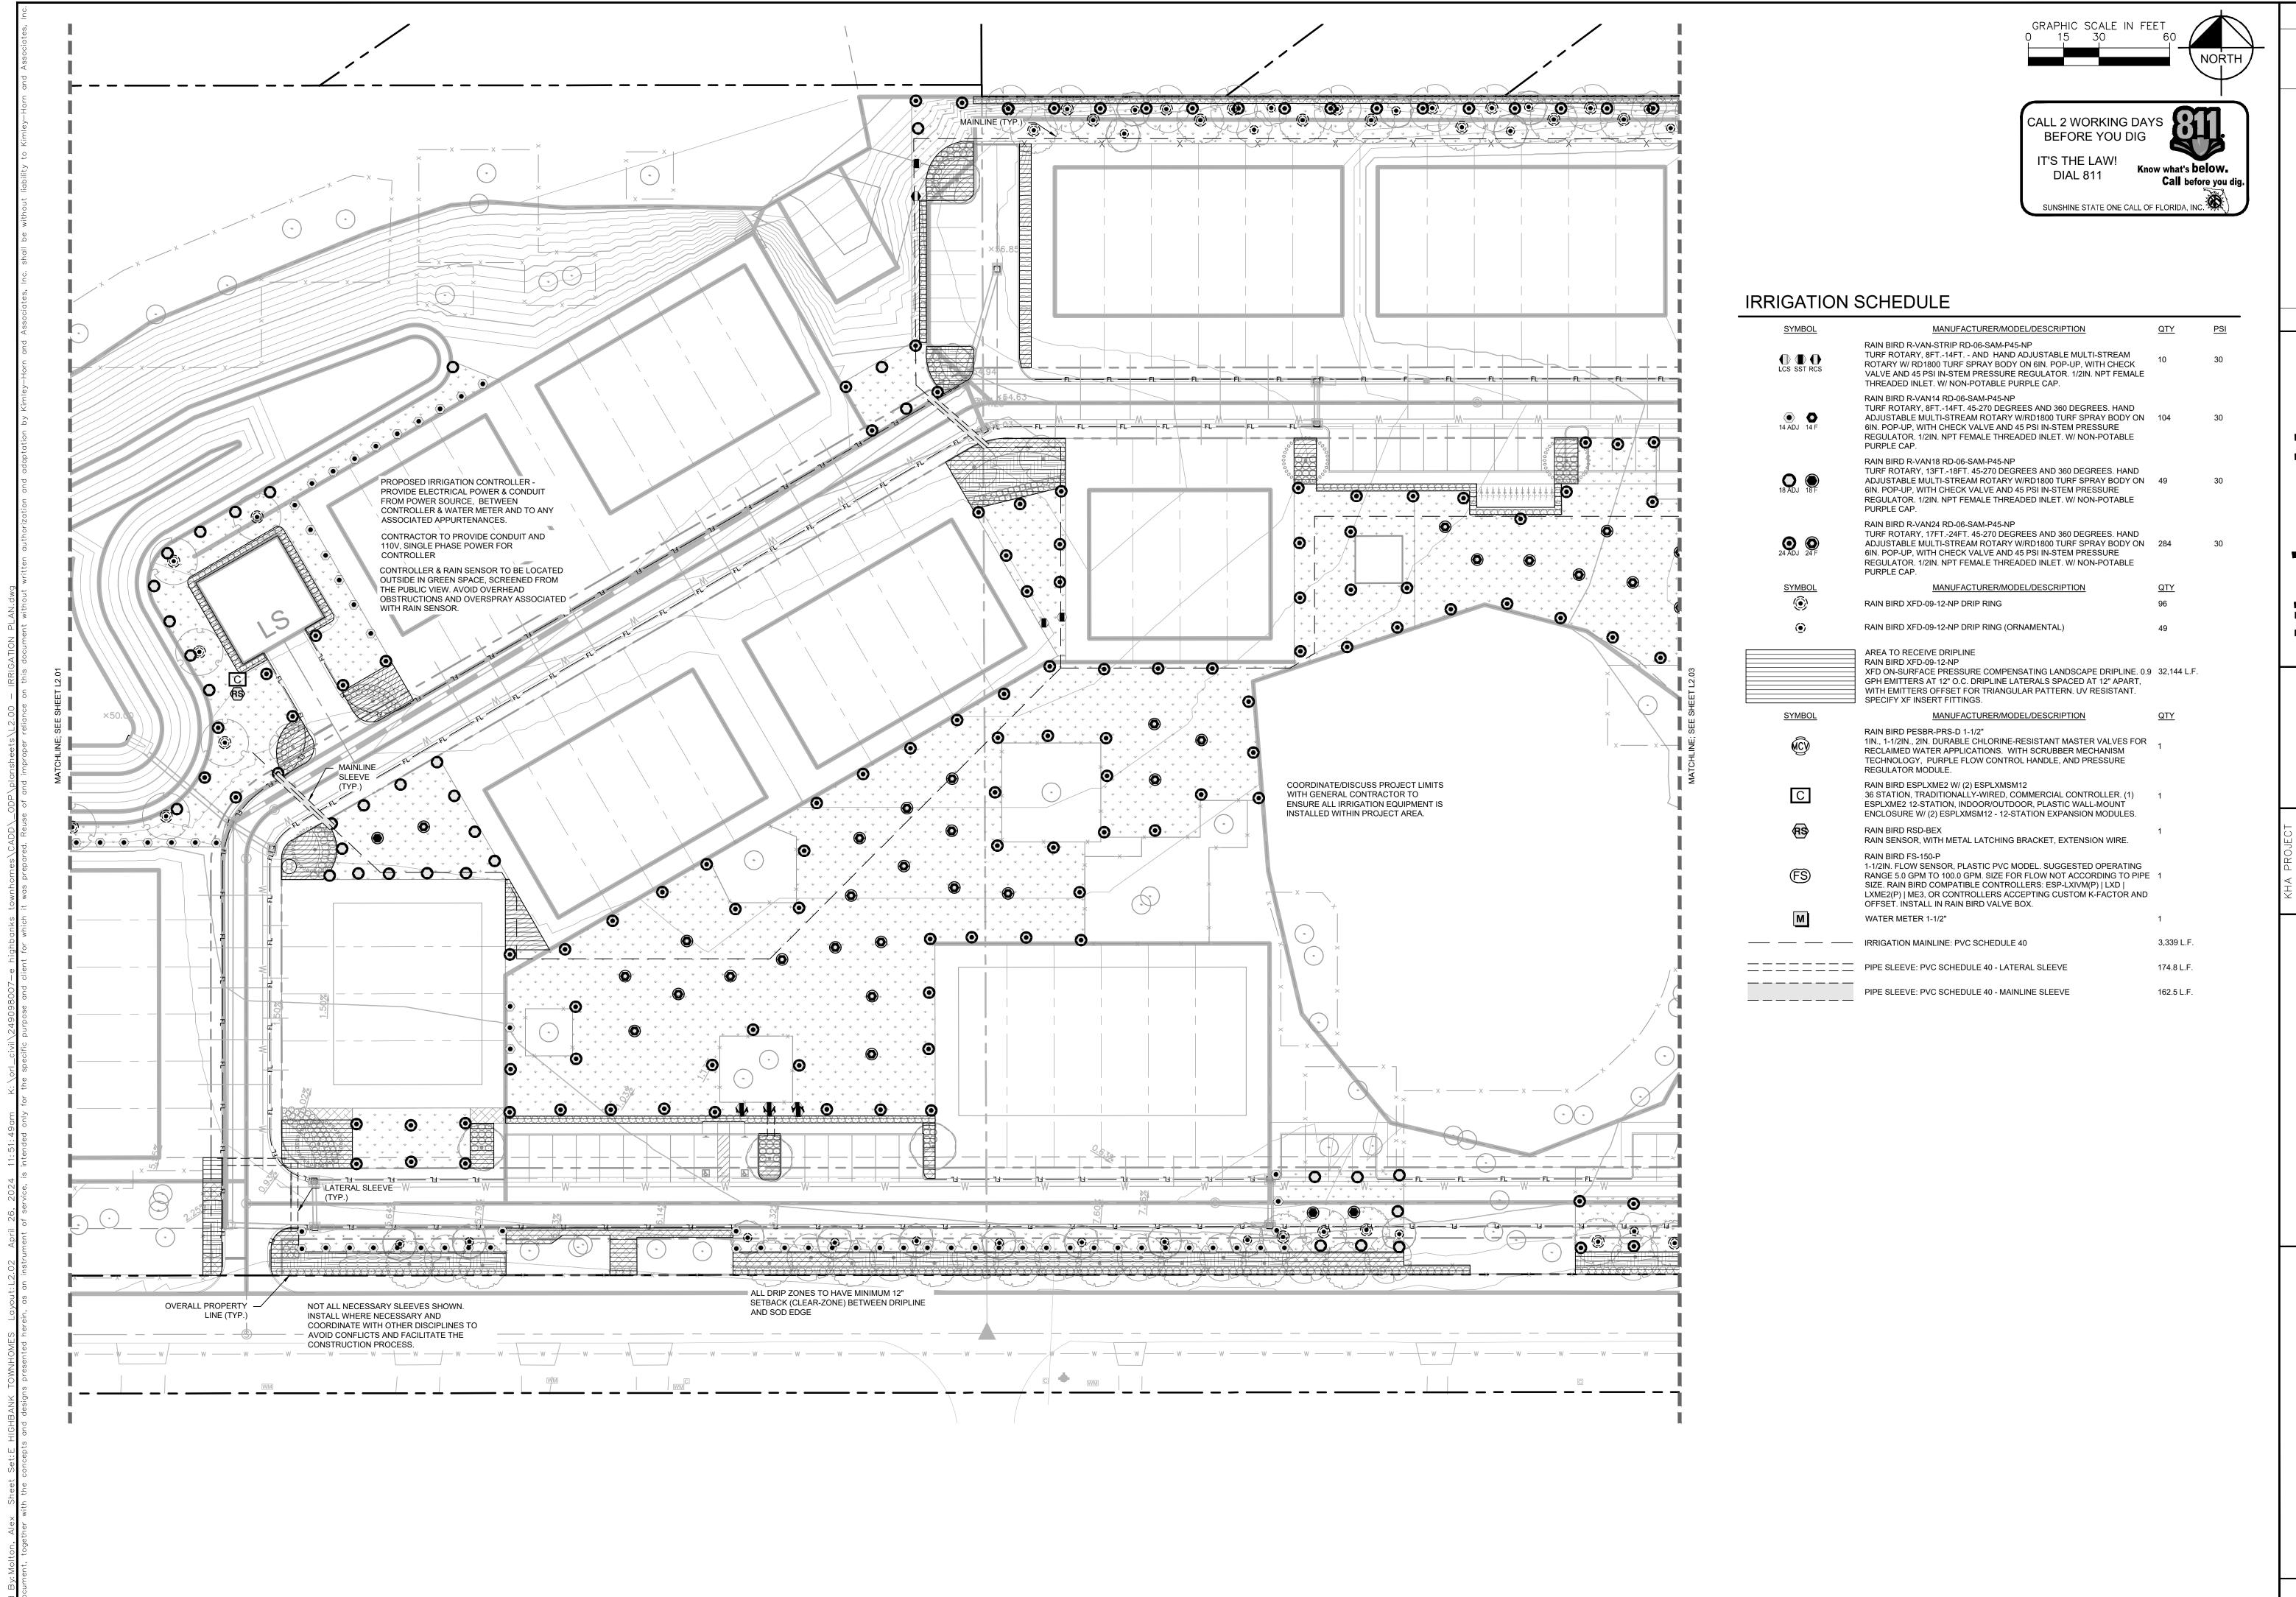


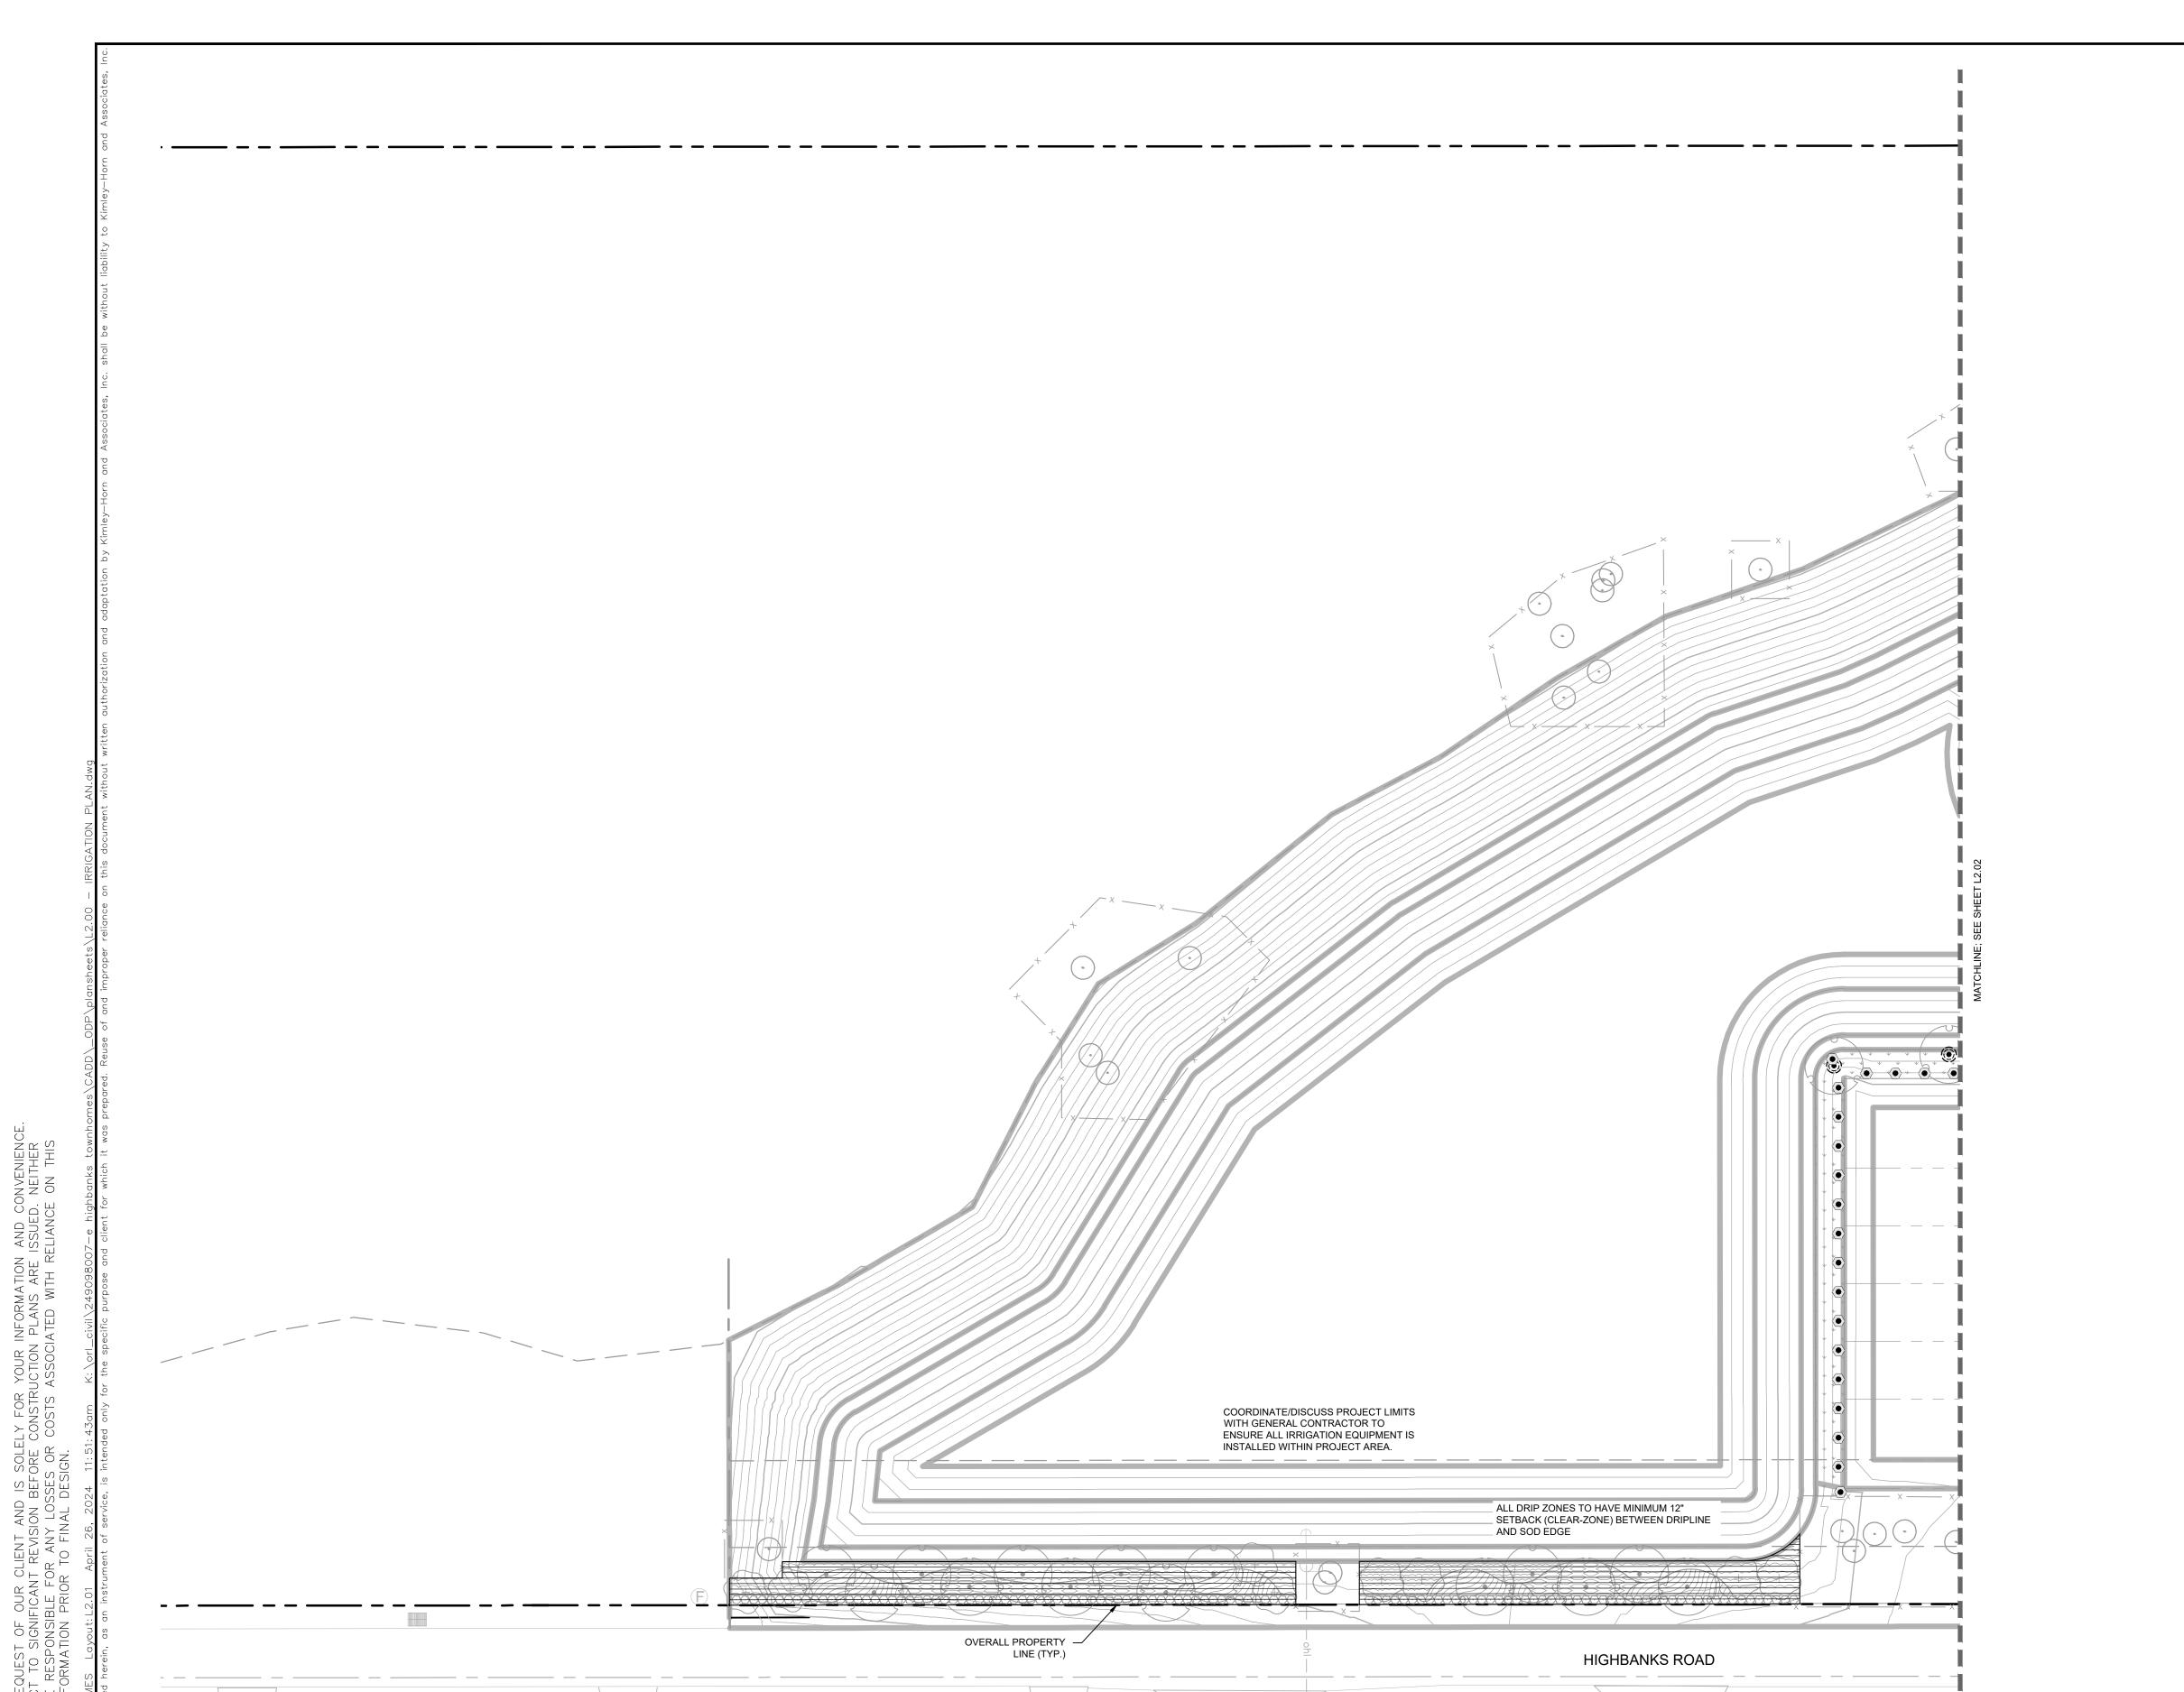

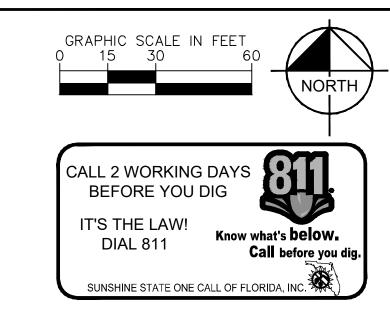IRRIGATION SCHEDULE

SYMBOL	MANUFACTURER/MODEL/DESCRIPTION	QTY	<u>P</u> :
CS SST RCS	RAIN BIRD R-VAN-STRIP RD-06-SAM-P45-NP TURF ROTARY, 8FT14FT AND HAND ADJUSTABLE MULTI-STREAM ROTARY W/ RD1800 TURF SPRAY BODY ON 6IN. POP-UP, WITH CHECK VALVE AND 45 PSI IN-STEM PRESSURE REGULATOR. 1/2IN. NPT FEMALE THREADED INLET. W/ NON-POTABLE PURPLE CAP.	10	30
14 ADJ 14 F	RAIN BIRD R-VAN14 RD-06-SAM-P45-NP TURF ROTARY, 8FT14FT. 45-270 DEGREES AND 360 DEGREES. HAND ADJUSTABLE MULTI-STREAM ROTARY W/RD1800 TURF SPRAY BODY ON 6IN. POP-UP, WITH CHECK VALVE AND 45 PSI IN-STEM PRESSURE REGULATOR. 1/2IN. NPT FEMALE THREADED INLET. W/ NON-POTABLE PURPLE CAP.	104	30
18 ADJ 18 F	RAIN BIRD R-VAN18 RD-06-SAM-P45-NP TURF ROTARY, 13FT18FT. 45-270 DEGREES AND 360 DEGREES. HAND ADJUSTABLE MULTI-STREAM ROTARY W/RD1800 TURF SPRAY BODY ON 6IN. POP-UP, WITH CHECK VALVE AND 45 PSI IN-STEM PRESSURE REGULATOR. 1/2IN. NPT FEMALE THREADED INLET. W/ NON-POTABLE PURPLE CAP.	49	30
24 ADJ 24 F	RAIN BIRD R-VAN24 RD-06-SAM-P45-NP TURF ROTARY, 17FT24FT. 45-270 DEGREES AND 360 DEGREES. HAND ADJUSTABLE MULTI-STREAM ROTARY W/RD1800 TURF SPRAY BODY ON 6IN. POP-UP, WITH CHECK VALVE AND 45 PSI IN-STEM PRESSURE REGULATOR. 1/2IN. NPT FEMALE THREADED INLET. W/ NON-POTABLE PURPLE CAP.	284	30
SYMBOL	MANUFACTURER/MODEL/DESCRIPTION	QTY	
©)	RAIN BIRD XFD-09-12-NP DRIP RING	96	
•	RAIN BIRD XFD-09-12-NP DRIP RING (ORNAMENTAL)	49	
	AREA TO RECEIVE DRIPLINE RAIN BIRD XFD-09-12-NP XFD ON-SURFACE PRESSURE COMPENSATING LANDSCAPE DRIPLINE. 0.9 GPH EMITTERS AT 12" O.C. DRIPLINE LATERALS SPACED AT 12" APART, WITH EMITTERS OFFSET FOR TRIANGULAR PATTERN. UV RESISTANT. SPECIFY XF INSERT FITTINGS.	32,144 L.F.	
SYMBOL	MANUFACTURER/MODEL/DESCRIPTION	QTY	
(C)	RAIN BIRD PESBR-PRS-D 1-1/2" 1IN., 1-1/2IN., 2IN. DURABLE CHLORINE-RESISTANT MASTER VALVES FOR RECLAIMED WATER APPLICATIONS. WITH SCRUBBER MECHANISM TECHNOLOGY, PURPLE FLOW CONTROL HANDLE, AND PRESSURE REGULATOR MODULE.	1	
С	RAIN BIRD ESPLXME2 W/ (2) ESPLXMSM12 36 STATION, TRADITIONALLY-WIRED, COMMERCIAL CONTROLLER. (1) ESPLXME2 12-STATION, INDOOR/OUTDOOR, PLASTIC WALL-MOUNT ENCLOSURE W/ (2) ESPLXMSM12 - 12-STATION EXPANSION MODULES.	1	
(RS)	RAIN BIRD RSD-BEX RAIN SENSOR, WITH METAL LATCHING BRACKET, EXTENSION WIRE.	1	
FS	RAIN BIRD FS-150-P 1-1/2IN. FLOW SENSOR, PLASTIC PVC MODEL. SUGGESTED OPERATING RANGE 5.0 GPM TO 100.0 GPM. SIZE FOR FLOW NOT ACCORDING TO PIPE SIZE. RAIN BIRD COMPATIBLE CONTROLLERS: ESP-LXIVM(P) LXD LXME2(P) ME3, OR CONTROLLERS ACCEPTING CUSTOM K-FACTOR AND OFFSET. INSTALL IN RAIN BIRD VALVE BOX.	1	
M	WATER METER 1-1/2"	1	
	IRRIGATION MAINLINE: PVC SCHEDULE 40	3,339 L.F.	
=======	PIPE SLEEVE: PVC SCHEDULE 40 - LATERAL SLEEVE	174.8 L.F.	
	PIPE SLEEVE: PVC SCHEDULE 40 - MAINLINE SLEEVE	162.5 L.F.	


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OWNHOME

SHEET NUMBER L2.02



TIEY-HORN AND ASSOCIATES, INC.
NGE AVENUE, SUITE 1000, ORLANDO, FL 328


DATE: 4/26/2024

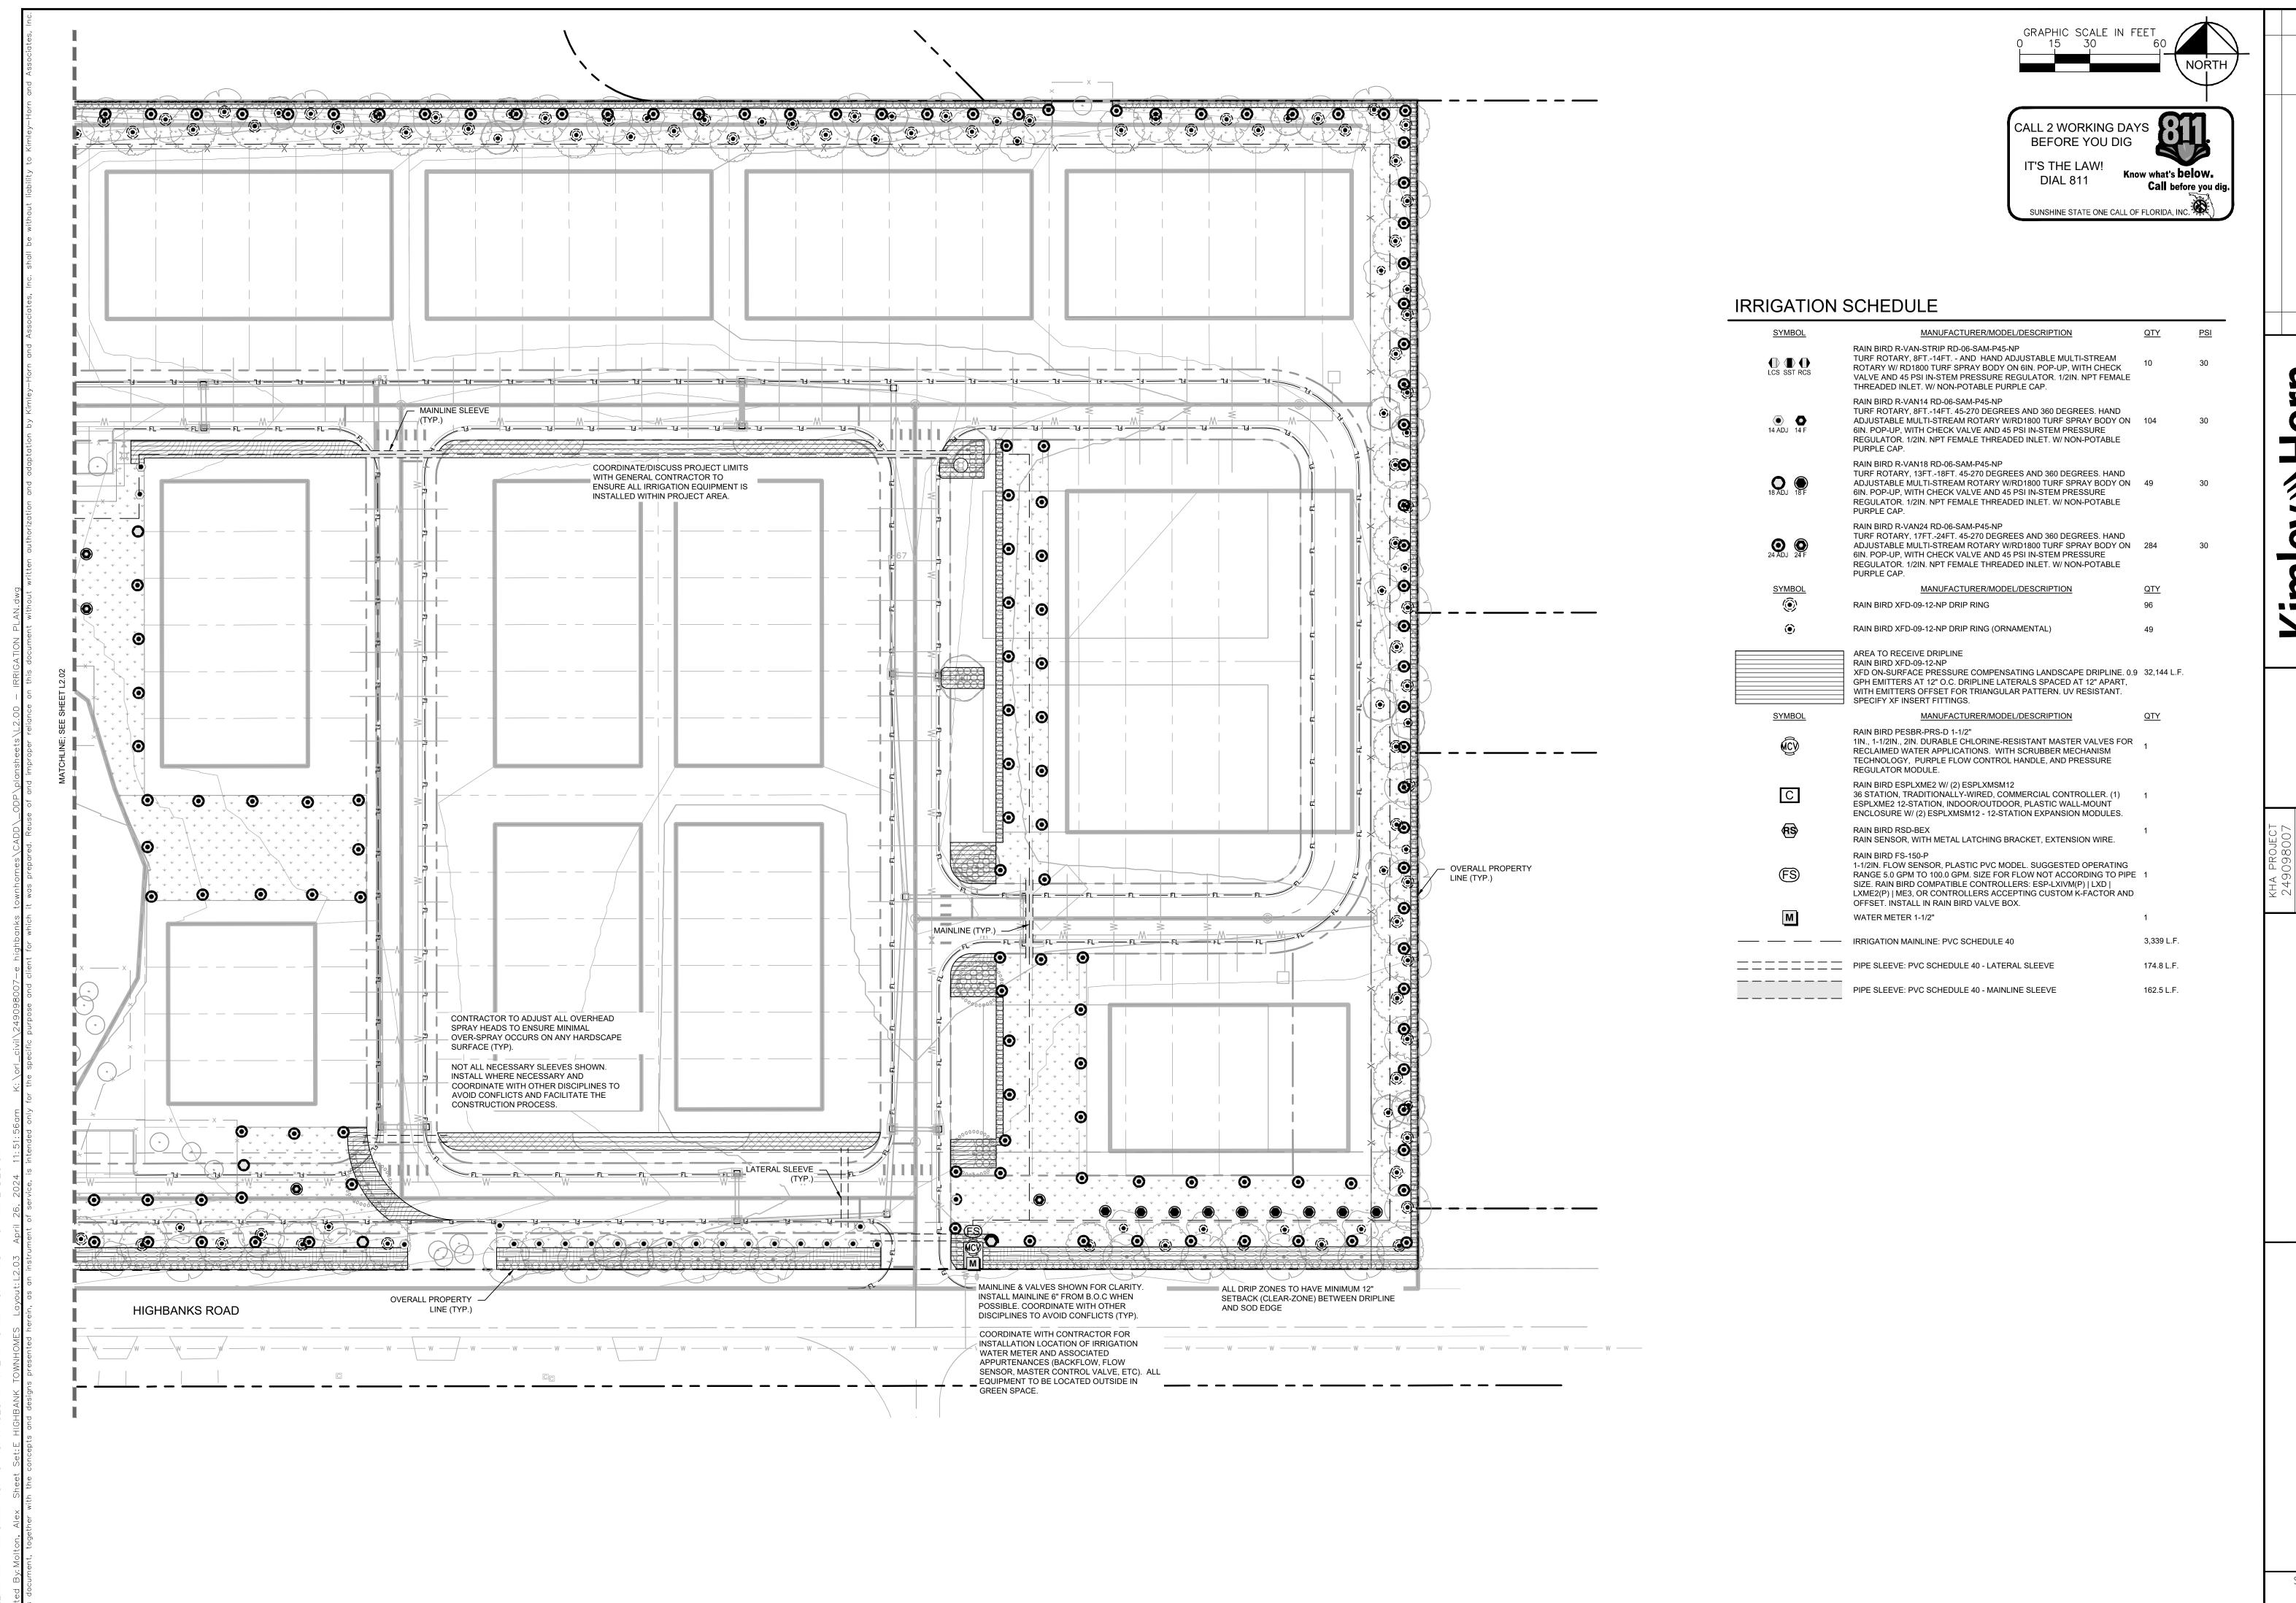SCALE AS SHOWN
DESIGNED BY KHA

IRRIGATION PLAI

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2. SET SPRAY HEADS 6" AND ROTORS 12" IN FROM BACK OF CURB OR 24" IF PAVEMENT HAS NO CURB.

3. IRRIGATION CONTRACTOR IS RESPONSIBLE FOR PERFORMING ALL NECESSARY MODIFICATIONS REQUIRED TO MEET THE SCHEMATIC INTENT OF THESE PLANS OUTLINE THE OVERALL LAYOUT THE SYSTEM AND IT SHALL BE THE RESPONSIBILITY OF THE CONTRACTOR TO ZONE THE SYSTEM ACCORDINGLY BASED ON FLOW AND PRESSURE AVAILABLE. CONTRACTOR SHALL BE RESPONSIBLE FOR VERIFYING THE FOLLOWING BUT NOT LIMITED TO AVAILABLE PRESSURE, CONNECTION ASSEMBLY, CAPACITY OF THE SYSTEM.

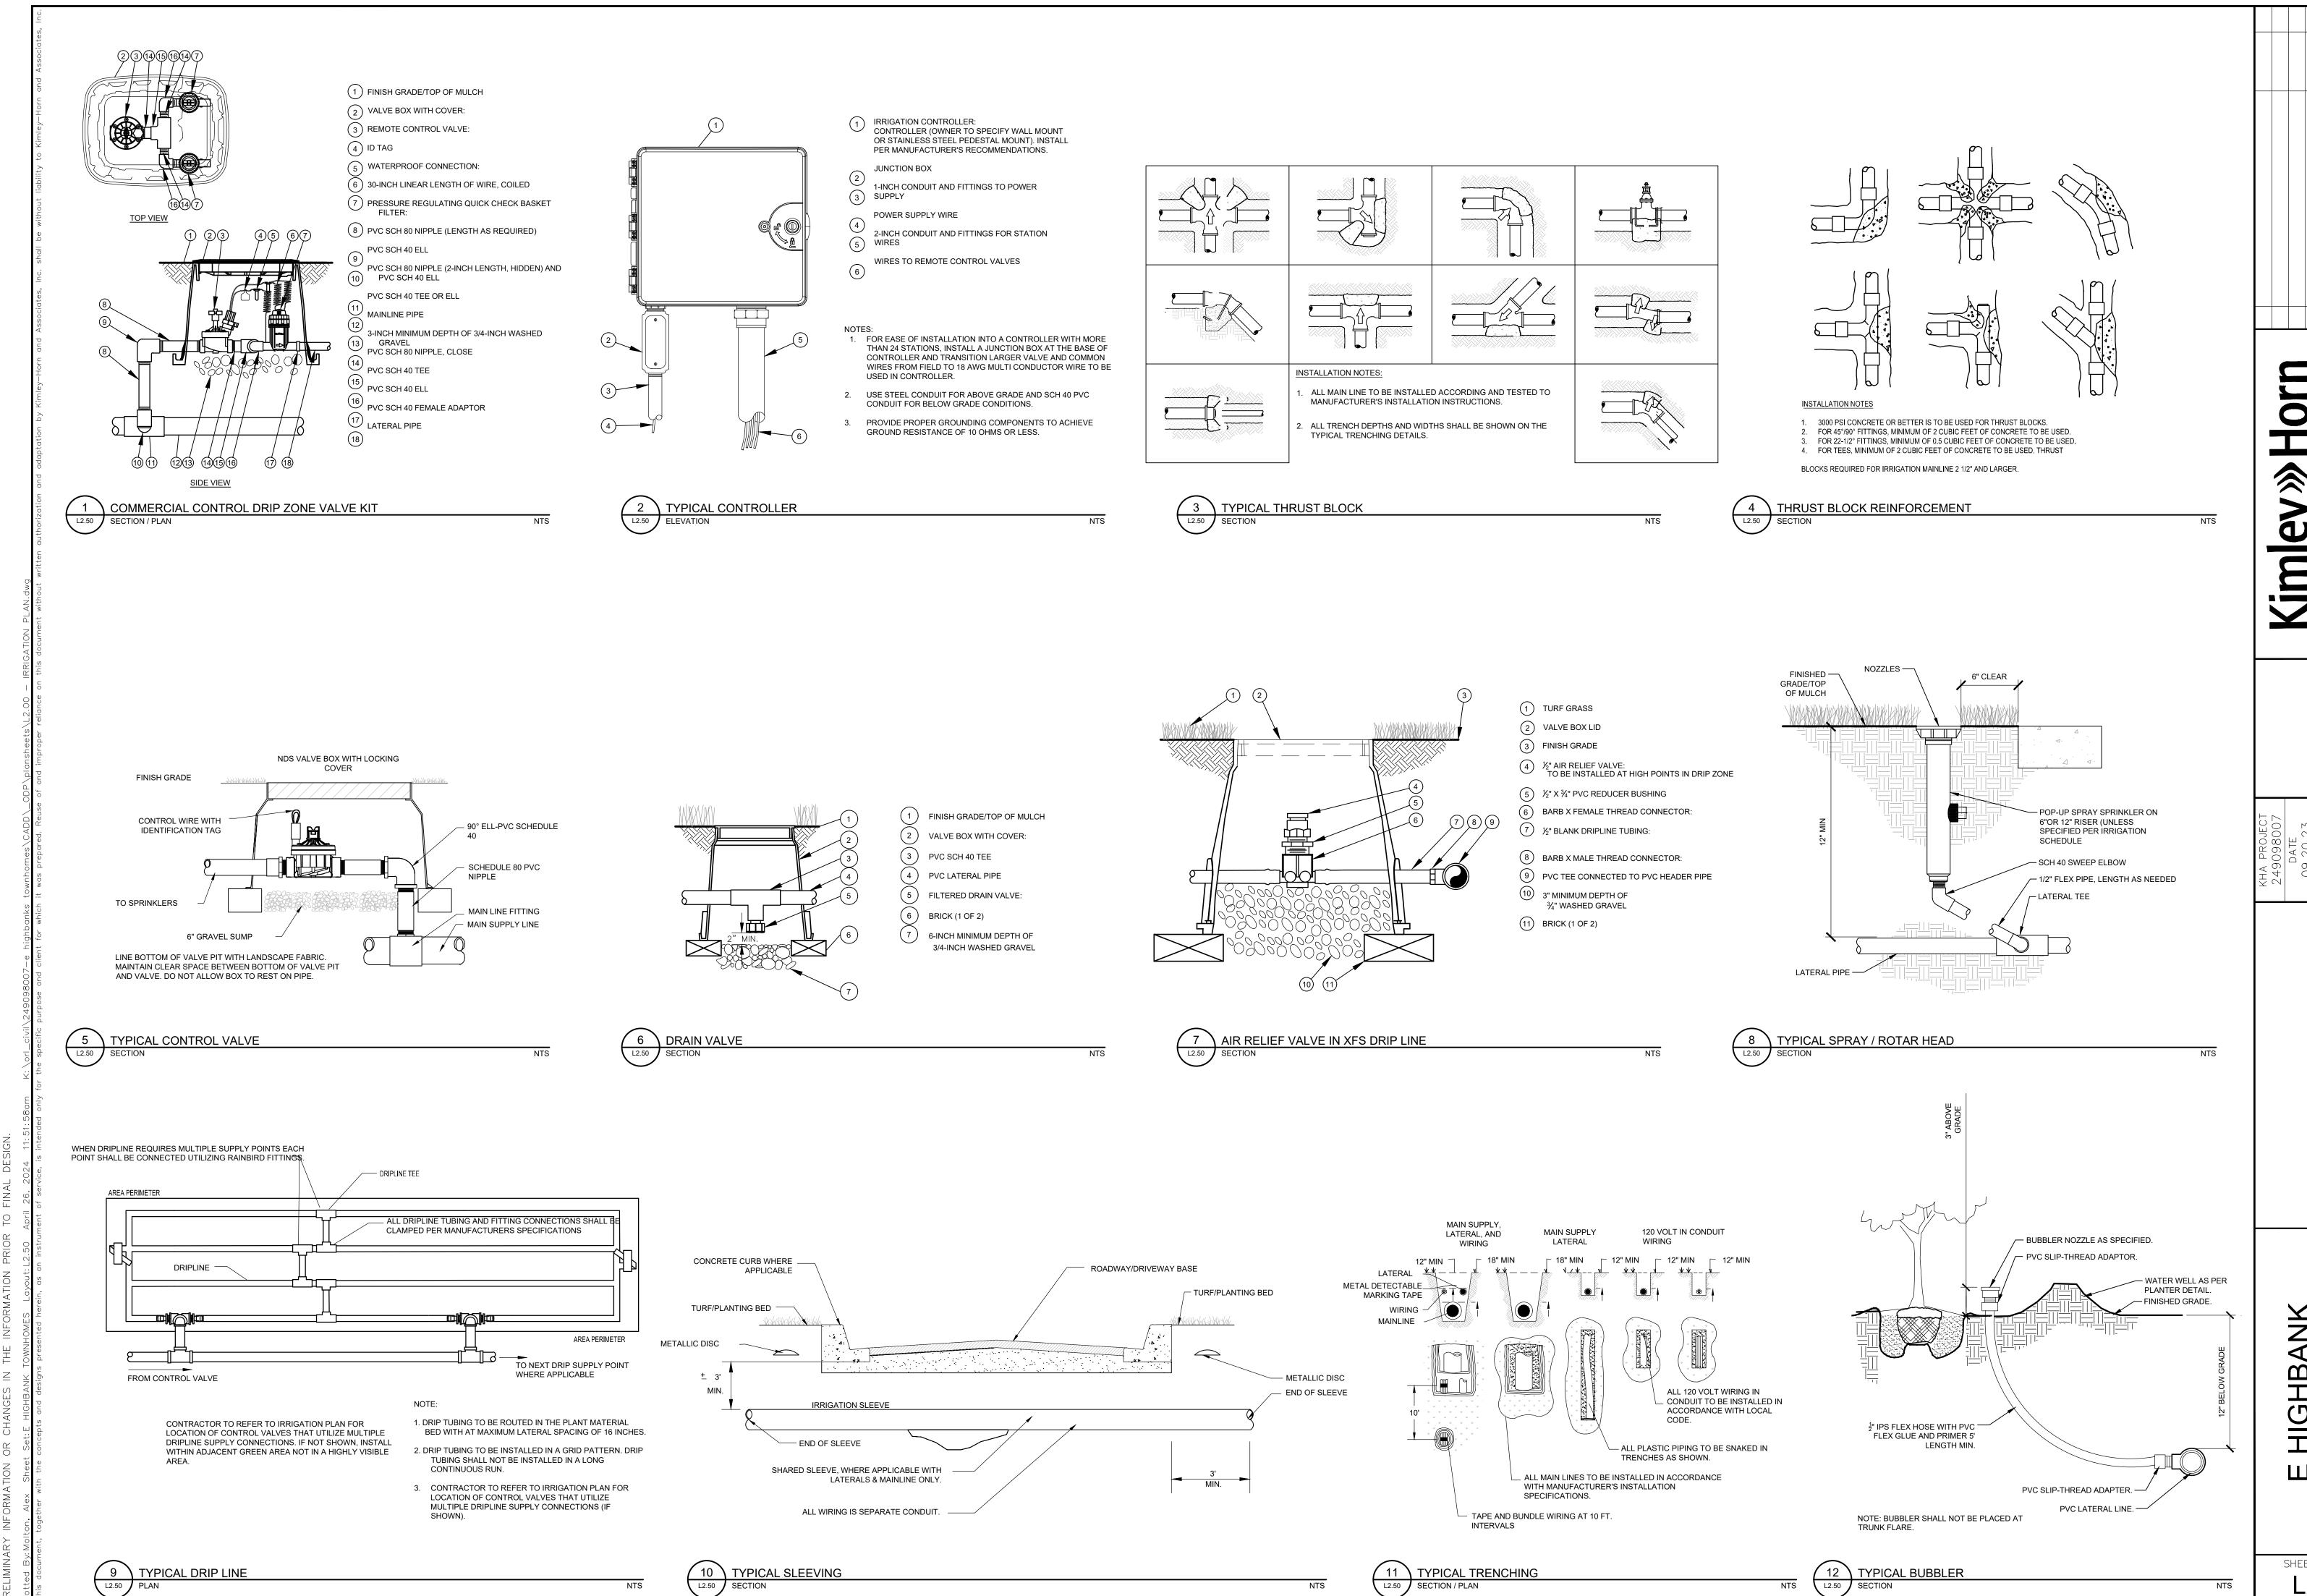4. CONTRACTOR TO PROVIDE NEW AUTOMATIC CONTROLLER FOR PROPOSED SYSTEM (NO BATTERY OPERATED CONTROLLERS ALLOWED). COORDINATE LOCATION WITH OWNER.

5. CONTRACTOR SHALL BE RESPONSIBLE FOR PROVIDING AUTOMATIC RAIN SENSOR. COORDINATE LOCATION W/ OWNER.

6. IRRIGATION SHALL NOT BE COMBINED ON A SINGLE ZONE AND SHALL BE ZONED ACCORDING TO IRRIGATION TYPE, PRECIPITATION RATE, AND THE SYSTEM'S AVAILABLE WATER / PRESSURE. CONTRACTOR TO SUBMIT SHOP DRAWINGS TO OWNER FOR REVIEW PRIOR TO INSTALLATION.

7. VERIFY LOCATIONS OF ALL UNDERGROUND UTILITIES PRIOR TO INSTALLATION OF IRRIGATION SYSTEM. ALL UTILITIES AND STRUCTURES MAY NOT BE SHOWN ON THESE PLANS-CONTRACTOR SHALL FIELD VERIFY.

8. CONTRACTOR TO FIELD VERIFY ALL POINT OF CONNECTION SOURCE INFORMATION INCLUDING PSI AND GPM PRIOR TO CONSTRUCTION.

9. INSTALLATION OF WORK SHALL BE COORDINATED WITH OTHER CONTRACTORS IN SUCH A MANNER AS TO ALLOW FOR A SPEEDY AND ORDERLY COMPLETION OF ALL WORK ON-SITE.

10. CONTRACTOR SHALL COORDINATE WITH THE PLANTING PLAN FOR PLANTER BED AND TREE LOCATIONS TO ENSURE ALL PLANT MATERIAL IS COVERED BY 100% HEAD-TO-HEAD IRRIGATION.

11. CONTRACTOR SHALL PROVIDE "AS-BUILT" DRAWINGS OF THE FINAL INSTALLATION TO OWNER AT SUBSTANTIAL COMPLETION BEFORE RECEIVING FINAL PAYMENT.

12. PRODUCTS SHALL BE AS SPECIFIED OR APPROVED EQUAL.

PRE-APPROVED MANUFACTURERS:

1. TORO
2. HUNTER

3. RAINBIRD

13. IRRIGATION CONTRACTOR SHALL SECURE ANY AND ALL NECESSARY PERMITS FOR THE WORK PRIOR TO COMMENCEMENT OF HIS OPERATIONS ON-SITE. COPIES OF THE PERMITS SHALL BE SENT TO THE OWNER/GENERAL CONTRACTOR. WORK IN THE R.O.W. SHALL CONFORM TO THE STANDARDS AND SPECIFICATIONS OF LOCAL AND/OR STATE

14. LOCATE ALL IRRIGATION LINES WITHIN LANDSCAPED AREAS WHENEVER POSSIBLE. ALL LINES UNDER PAVEMENT MUST BE SLEEVED WITHIN SCH. 40 PVC 2x SIZE OF PIPE AND FREE OF STONES/DEBRIS. ALL VALVES SHALL BE LOCATED WITHIN LANDSCAPED AREAS.

15. MAINLINE SHALL NOT BE LOCATED WITHOUT PRIOR APPROVAL OF THE OWNER'S REPRESENTATIVE.

16. THE IRRIGATION CONTRACTOR SHALL BE DIRECTLY RESPONSIBLE FOR SLEEVING AND DIRECTIONAL BORES.

17. ALL SLEEVES UTILIZED BY THE IRRIGATION CONTRACTOR WHETHER INSTALLED BY HIM OR NOT, SHALL BE LOCATED ON THE "AS-BUILT" DRAWINGS. THE DEPTH BELOW FINISH GRADE, TO THE NEAREST FOOT OF EACH END OF THE SLEEVE SHALL BE NOTED AT EACH SLEEVE LOCATION ON THE "AS-BUILT" DRAWINGS. ALL SLEEVES ON PLAN FOR WALL PENETRATIONS AND UNDER SIDEWALKS SHALL BE SIZED TWO PIPE SIZES GREATER THAN THE PIPE IT CARRIES.

18. ALL PRESSURIZED MAINLINES AND LATERALS UNDER PAVEMENT SHALL BE WITHIN SCH. 40 PVC SLEEVES. WHERE ELECTRIC OR HYDRAULIC VALVE CONTROL LINES PASS THROUGH A SLEEVE WITH OTHER MAIN OR LATERAL LINES THEY SHALL BE CONTAINED WITHIN A SEPARATE, SMALLER CONDUIT.

19. NUMBER THE TOP OF ALL VALVE BOX LIDS WITH MINIMUM 1" HEIGHT BLACK LETTERS TO CORRESPOND TO AUTOMATIC AND GATE VALVE BOXES SHALL BE LABELED IN A SIMILAR MANNER WITH THE DESIGNATION "HB". LETTER OUTSIDE OF TIME CLOCK CABINETS TO CORRESPOND WITH IRRIGATION CLOCK
PROGRAM DESIGNATION

20. THE IRRIGATION CONTRACTOR SHALL INSTALL A COLOR CODED METAL DETECTABLE MARKING TAPE WHICH CLEARLY NOTES: "CAUTION: IRRIGATION LINE BURIED BELOW." THE TAPE SHALL BE INSTALLED THE FULL LENGTH OF THE IRRIGATION MAINLINE.

21. ELECTRIC SERVICE TO THE CONTROLLER SHALL BE PROVIDED BY THE GENERAL CONTRACTOR.

22. ALL 24 VAC WIRING FROM DECODER TO VALVE SHALL BE OF DIRECT BURIAL COPPER WIRE. MAXIMUM LENGTH OF WIRE FROM DECODER TO VALVE SHALL NOT EXCEED 400 FEET. AS FOLLOWS: CONTROL WIRES - #14
COMMON WIRES - #14

23. ALL VALVES, SPLICES WITHIN CONTROL LINES, AND QUICK COUPLERS SHALL BE LOCATED WITHIN NDS VALVE BOXES AS FOLLOWS:
-RECTANGULAR 12"X17" HEAVY DUTY BOX. (PURPLE COVER FOR REUSE TO BE PROVIDED WHERE APPROPRIATE).

24. ALL IRRIGATION HEADS/DRIP TUBING SHALL BE LOCATED ONE (1) FOOT FROM BACK OF CURB WHEN NEXT TO A ROADWAY. (THIS SHALL NOT INCLUDE PARKING AREAS OR DRIVE AISLES).

25. HEADS, LATERALS, EMITTERS, AND VALVES ARE NOT SHOWN, BUT ARE NECESSARY FOR A FULLY FUNCTIONING IRRIGATION SYSTEM.

26. LOCATE ALL VALVES IN PLANTING BEDS WITH A MINIMUM OF 3'-0" FROM BACK OF CURB OR EDGE OF PAVEMENT, UNLESS OTHERWISE NOTED. PIPE SIZES ON EITHER SIDE OF SECTION VALVES CONNECTING MAINLINE TO SECTION VALVES CONNECTING MAINLINE TO SECTION VALVES CONNECTING MAINLINE TO SECTION VALVE SIZE. WHERE MAINLINES RUN PARALLEL TO PAVEMENT OR CURBING, THE MAINLINE SHALL BE OFFSET 2'-0" FROM THE EDGE OF PAVEMENT OR CURB.

27. IRRIGATION ZONES SHALL BE SEPARATED FOR HIGH AND LOW WATER USE REQUIREMENTS AND OPERATED ON DIFFERENT WATERING CYCLES. BUBBLERS, DRIPLINE, AND SPRAY HEADS SHALL BE SEPARATED ON DIFFERENT VALVES. AT NO TIME SHALL MULTIPLE IRRIGATION HEAD TYPES BE LOCATED ON THE SAME VALVE.

28. ALL DRIP ZONES SHALL BE INSTALLED WITH A FLUSH VALVE AND AIR RELIEF VALVE. IN THE EVENT THAT A DRIP ZONE HAS MORE THAN ONE AIR RELIEF VALVE OR FLUSH VALVE WILL BE REQUIRED FOR THAT ZONE. DRIPLINE SHALL PROVIDE 0.9 GPH EMITTERS, 12" O.C. WITH 12" LINE SPACING AT A MINIMUM.

29. ALL WIRING FOR CONNECTION OF THE VALVES TO THE CONTROLLER SHALL FOLLOW MANUFACTURERS SPECIFICATIONS. IF REQUIRED, ALL WIRING FOR A TWO WIRE PATH SHALL BE WITH RED/BLUE TWISTED PAIR 14 AWG. ELECTRIC CONTROL LINES FROM THE DECODER TO THE SOLENOID VALVES SHALL BE TWISTED PAIR 18 AWG. ALL DECODERS SHALL BE GROUNDED EVERY 1,000 L.F. OR EVERY 10 DEVICES. ALL WIRE SHALL BE FURNISHED IN MINIMUM 2,500' REELS AND SPLICING SHALL BE MINIMIZED. BURY SPLICE KIT. ALL 24 VOLT WIRING SHALL BE MINIMIZED. BURY SPLICE KIT. ALL 24 VOLT WIRING SHALL BE TWO WIRE PATH. CONTRACTOR SHALL FOLLOW ALL MANUFACTURER'S REQUIREMENTS FOR THIS INSTALLATION. TWO WIRE SYSTEM SHALL HAVE 2-WAY COMMUNICATIONS FIELD PROGRAMMABILITY, STATION SPECIFICATIONS AND INTEGRATED SURGE PROTECTION.

30. ALL CONTROL WIRE SHALL BE INSTALLED IN A 1 $\frac{1}{4}$ " ELECTRICAL CONDUIT.

31. SMALLEST DIAMETER LATERAL PIPE SHALL BE 3/4".

32. IRRIGATION SYSTEM SHALL BE CAPABLE OF SUPPLYING AN AVERAGE OF 1.05" OF WATER PER WEEK WITHIN WATERING RESTRICTIONS AS APPLICABLE.

33. IRRIGATION SYSTEM SHALL NOT BE INSTALLED THROUGH EXISTING, OR PRESERVED PLANT COMMUNITIES. DO NOT TRENCH THROUGH EXISTING ROOT SYSTEMS OF ANY VEGETATION INTENDED TO BE PRESERVED.

34. CONTRACTOR TO MINIMIZE IRRIGATION OVERTHROW TO IMPERVIOUS AND NATURAL AREAS THROUGH FIELD ADJUSTMENTS TO INDIVIDUAL HEADS.

35. ALL AREAS DISTURBED DURING CONSTRUCTION SHALL BE RESTORED BY THE CONTRACTOR TO THE CONDITION DENOTED ON THE LANDSCAPE PLAN.

36. IRRIGATION PIPING INSTALLED UNDER ROADS AND SIDEWALKS SHALL BE IN SCHEDULE 40 PVC SLEEVING AT 2X THE PIPE SIZE. ALL SLEEVING SHALL BE FREE OF STONES AND DEBRIS.

37. IRRIGATION SOURCE TO BE EITHER WELL, POTABLE, OR NON-POTABLE WATER. IRRIGATION CONTRACTOR TO VERIFY SOURCE PRIOR TO DESIGN.

38. POINT OF CONNECTION TO BE DETERMINED BY OWNER. IRRIGATION SYSTEM CONNECTIONS TO THE LOCAL JURISDICTION SERVICE SHALL COMPLY WITH ALL APPLICABLE CODES.

39. IRRIGATION CONNECTION MAY REQUIRE BACKFLOW PREVENTION, VERIFY WITH LOCAL JURISDICTION.

40. IRRIGATION SYSTEM SHALL COMPLY WITH THE LOCAL JURISDICTION LAND DEVELOPMENT CODE.

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1 TYPICAL SCHEMATIC IRRIGATION NOTES